

# LOUISIANA KITCHEN BRENTWOOD, CA



# RECEIVED

Feb 12, 2024

CITY OF BRENTWOOD
COMMUNITY DEVELOPMENT DEPT

T SUMMARY	SHEET INDI	EX	
2022 CBC	GENERAL		
	-		
	BOUNDARY SHEET		
	ARCHITECTURAL		
	COVER SHEET		
	PROPOSED OVERALL SITE PLAN - DEMOLITIC PROPOSED OVERALL SITE PLAN	ON	
	PROPOSED ENLARGED SITE PLAN SITE DETAILS TRASH ENCLOSURES		
	PROPOSED FLOOR PLAN		
68	PROPOSED EXTERIOR ELEVATIONS PROPOSED BUILDING SECTIONS		
N OF PROJECT	CIVIL		
	COVER SHEET		
'S RESTAURANT	UTILITY PLAN EROSION CONTROL PLAN		
	LANDSCAPE		
	PRELIMINARY LANDSCAPE PLAN	<del></del>	
	SITE LIGHTING PLAN & PHOTOMETRIC DRAW	 /ING	
	BUILDING MTD LIGHTING PLAN & PHOTOMET		
	PROJECT DIREC	TORY	
	CLIENT	TOPOGRAPHY	
	GHAI MANAGEMENT SERVICES, INC	BASE CONSULTING	
	SUNNY GHAI 25 E. AIRWAY BLVD.	GROUP NEIL THONESEN	
	LIVERMORE, CA	1713 11TH STREET SUITE 1	
	DESIGNER	REEDLEY, CA	
	AGJM DESIGN STUDIO	CIVIL	
	MIKE JIBAJA 15998 SKYRIDGE DR.	MOUA ENTERPRIS	
	RIVERSIDE, CA	PETER MOUA	
		LANDSCAPE	
		KIENAN HERMAN GREEN DESIGN 1464 POPINJAY DF RENO, NV	
<b>Ү МАР</b>	VICINITY MAP		
Sand Hill  Brownstring 8d  Date 8d  Knightsen  Lane Tree My Script, Carptly FSirit  Embolarity closes  McDauley Estate Moreyards  Series 8d  McDauley Estate Moreyards  Series Nursery/ Landscaping on Eden  Cresod 8c  Bitch  Brentwood  Weteraha Park  Veregrands  Description of the Common Series Sixtensing on Eden  Cresod 8c  Bitch  Brentwood  Veteraha Park	Technology Way  Technology Way  Jack in the Box Grifled Chicken Sandreich  PROPOSED NEW POPEYE'S  Taca Beil	Woodfield Ln  Woodfield Ln  Woodfield Ln  Wancy Sy  Mancy Sy  Dollar General Dollar ancie  Village Community Resource Center  Willage Dr	
	2022 CBC A-2 RESTAURANT BBPS 3.4 ACRES 2,536 SF V-B NO 13 SPACES 68  N OF PROJECT  S RESTAURANT  Bertwood  Wind restricted to the server of th	DESIGNER  A2 GOVER SHEET  RESTAURANT  BBPS  3.4 A AGRES  2.368 SF  V-B  NO  13 SPACES  88  NO  NOF PROJECT  NOF PROJECT  NOF PROJECT  NOF PROJECT  COVER SHEET  PROPOSED DURLINGS SITE PLAN - DEMOLTING PROPOSED DURLINGS SITE PLAN SITE DETAILS TRASH ENCLOSURES PROPOSED DURLINGS SECTIONS FINISHES  CIVIL  COVER SHEET  PROPOSED BUILDING SECTIONS  FINISHES  NOF PROJECT  COVER SHEET  GRADING PLAN  UTILITY PLAN  EROSION CONTROL PLAN  DAMA MAP  LANDSCAPE  PRELIMINARY LANDSCAPE PLAN  PREVIOUS PLAN S PHOTOMETRIC DRAW  BUILDING MTD LIGHTING PLAN S PHOTOMETRIC DRAW  BUILDING MTD LIGHTING PLAN A PHOTOMETRIC DRAW  BUILDING STRUCKERS, INC  SURNY CHAI  25 E. ARRWAY BLVD.  LIVERMORE, CA  DESIGNER  AGJIM DESIGN STUDIO  MIKE JIBAJA  SISSE SOFRIDED DR.  BY MAP  VICINITY MAP  VICINITY MAP  VICINITY MAP  VICINITY MAP  PROPOSED  NEW POPEYE'S	



PROJECT MANAGER: MIKE JIBAJA

15998 SKYRIDGE DR

RIVERSIDE, CA 92503

T: 909.520.3381

E: MIKE@AGJMDESIGN.COM

CLIENT: SUNNY GHAI
GHAI MANAGEMENT SERVICES, INC.
25 E. AIRWAY BLVD.
LIVERMORE CA
T: 510.573.5905
E: SUNNY@GHAIMANAGEMENT.COM


ADDRESS: BRENTWOOD BLVD. BRENTWOOD CA, 94513

ZONING: BBSP LOT SIZE: 3.4 ACRES

ASSESSORS #: 016-150-106-9

POPEYES

COVER SHEET

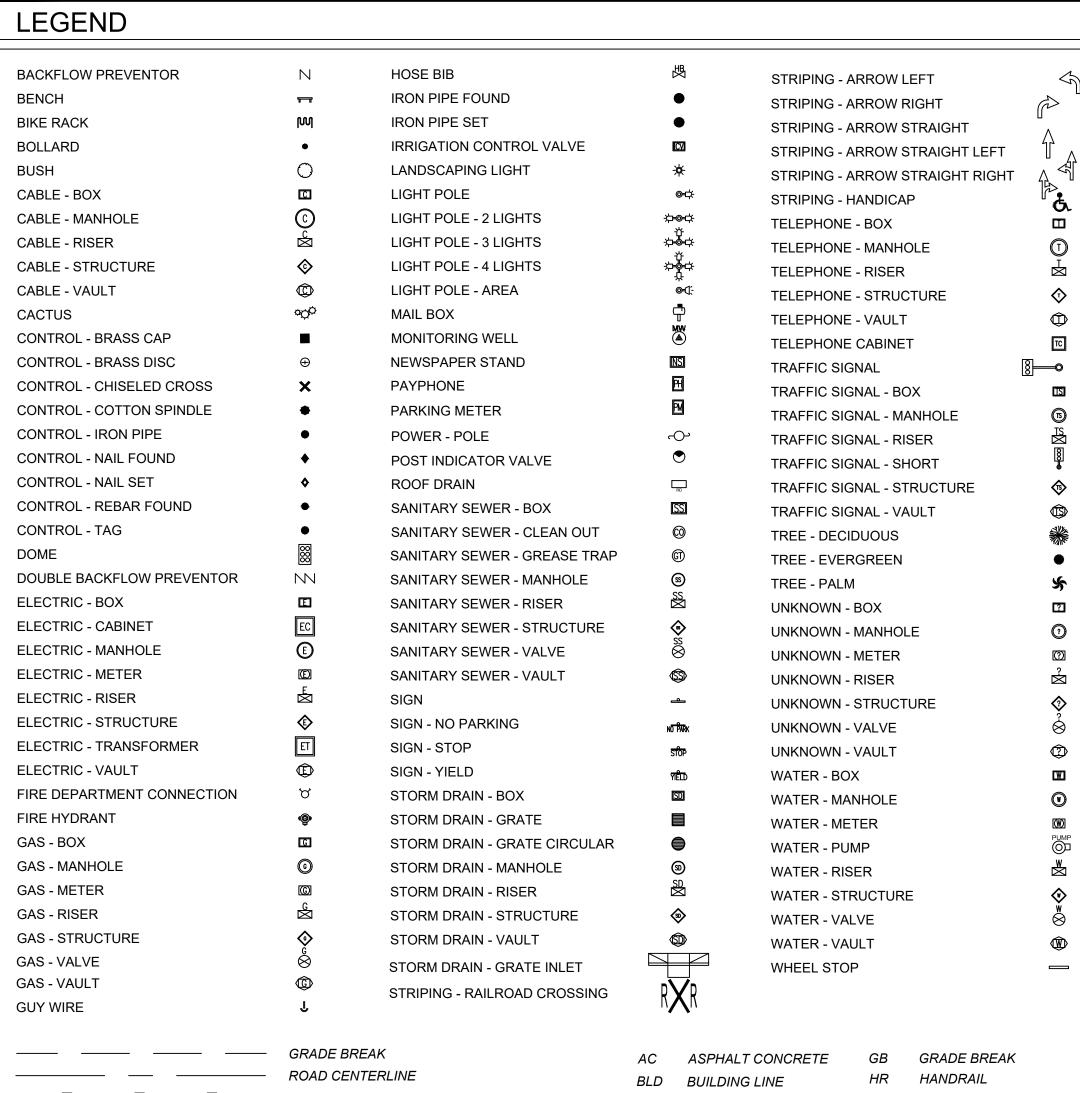

	GRADE BREAK
	ROAD CENTERLINE
	WOOD FENCE
	CHAIN LINK FENCE
××	WIRE FENCE
	METAL FENCE
———— UGT ————	TELEPHONE LINE - UNDERGROUND
——————————————————————————————————————	TELEPHONE LINE - OVERHEAD
——————————————————————————————————————	ELECTRIC LINE - OVERHEAD
——————————————————————————————————————	ELEC. & TELE. LINE - OVERHEAD
———— UGE ————	ELECTRIC LINE - UNDERGROUND
W	WATER LINE - UNDERGROUND
22	SEWER LINE - UNDERGROUND
	STORM LINE - UNDERGROUND
CTV	CABLE LINE - UNDERGROUND
———— UGU —————	UNKNOWN LINE - UNDERGROUND
G	GAS LINE - UNDERGROUND
IRR	IRRIGATION - UNDERGROUND
	FEMA BOUNDARY LINE
///////////////////////////////////////	BUILDING OUTLINE
	ADJACENT PROPERTY LINE

SECTION LINE

PROPERTY BOUNDARY LINE

BS BUS STOP INVERT ELEVATION FF FINISHED FLOOR CNC CONCRETE CR CROWN OF ROAD FFD FINISHED FLOOR DOUBLE LIP OF CURB DW DRIVEWAY EXISTING GRADE SS SANITARY SEWER EDGE OF PAVEMENT ST STRIPING FL FLOW LINE STB STRIPING - BROKEN FLP FLOW LINE PIPE STD STRIPING - DOUBLE FM FENCE - METAL SW SIDEWALK FW FENCE - WIRE TBC TOP BACK OF CURB FWD FENCE - WOOD TFC TOP FACE OF CURB

BASIS OF BEARINGS: THE CENTERLINE OF SUSAN STREET AS SHOWN ON PARCEL MAP FILED IN BOOK 70 AT PAGES 31.
TAKEN TO BEAR: NORTH 1°19'46" WEST

BASIS OF ELEVATIONS: 2IN BRASS CAP, STAMPED KRISTI 1997
FOUND FLUSH ON TOP OF HEADWALL, AT THE NORTHWEST END OF THE HEADWALL.
HEADWALL IS LOCATED 200' WESTERLY OF THE CENTER OF THE INTERSECTION OF BRENTWOOD BLVD AND SELLERS AVENUE, WEST OF THE RAIL ROAD TRACK, APPROX 270' +/- NORTH OF PAYNE AVENUE
ELEVATION = 65.8' NAVD88

SITE BENCHMARKS:

BASE CONTROL POINT NUMBER 1.

NAIL FLUSH.

**NOTES** 

ELEVATION = 67.48' NAVD88, AS SHOWN ON TOPO SHEET 1.


4. THIS SURVEY IS VALID ONLY IF THE DRAWING INCLUDES THE SEAL AND SIGNATURE OF THE SURVEYOR.

 CERTIFICATION IS MADE TO THE ORIGINAL PURCHASER OF THE SURVEY, IT IS NOT TRANSFERABLE TO ADDITIONAL INSTITUTIONS OR SUBSEQUENT OWNERS.

6. SUBSURFACE AND ENVIRONMENTAL CONCERNS WERE NOT EXAMINED OR CONSIDERED AS A PART OF THIS SURVEY.

THE LOCATIONS OF UNDER GROUND UTILITIES AS SHOWN HEREON ARE BASED ON ABOVE GROUND STRUCTURES AND RECORD DRAWINGS PROVIDED TO THE SURVEYOR. LOCATIONS OF UNDERGROUND UTILITIES/STRUCTURES MAY VARY FROM LOCATIONS SHOWN HEREON. NO EXCAVATIONS WERE MADE DURING THE PROCESS OF THIS SURVEY TO LOCATE UNDERGROUND UTILITIES/STRUCTURES. DEPTHS UNKNOWN.

8. EVERY DOCUMENT OF RECORD REVIEWED AND CONSIDERED AS A PART OF THIS SURVEY IS NOTED HEREON. ONLY THE DOCUMENTS NOTED HEREON WERE SUPPLIED TO THE SURVEYOR. THERE MAY EXIST OTHER DOCUMENTS OF RECORD WHICH WOULD AFFECT THIS PARCEL.

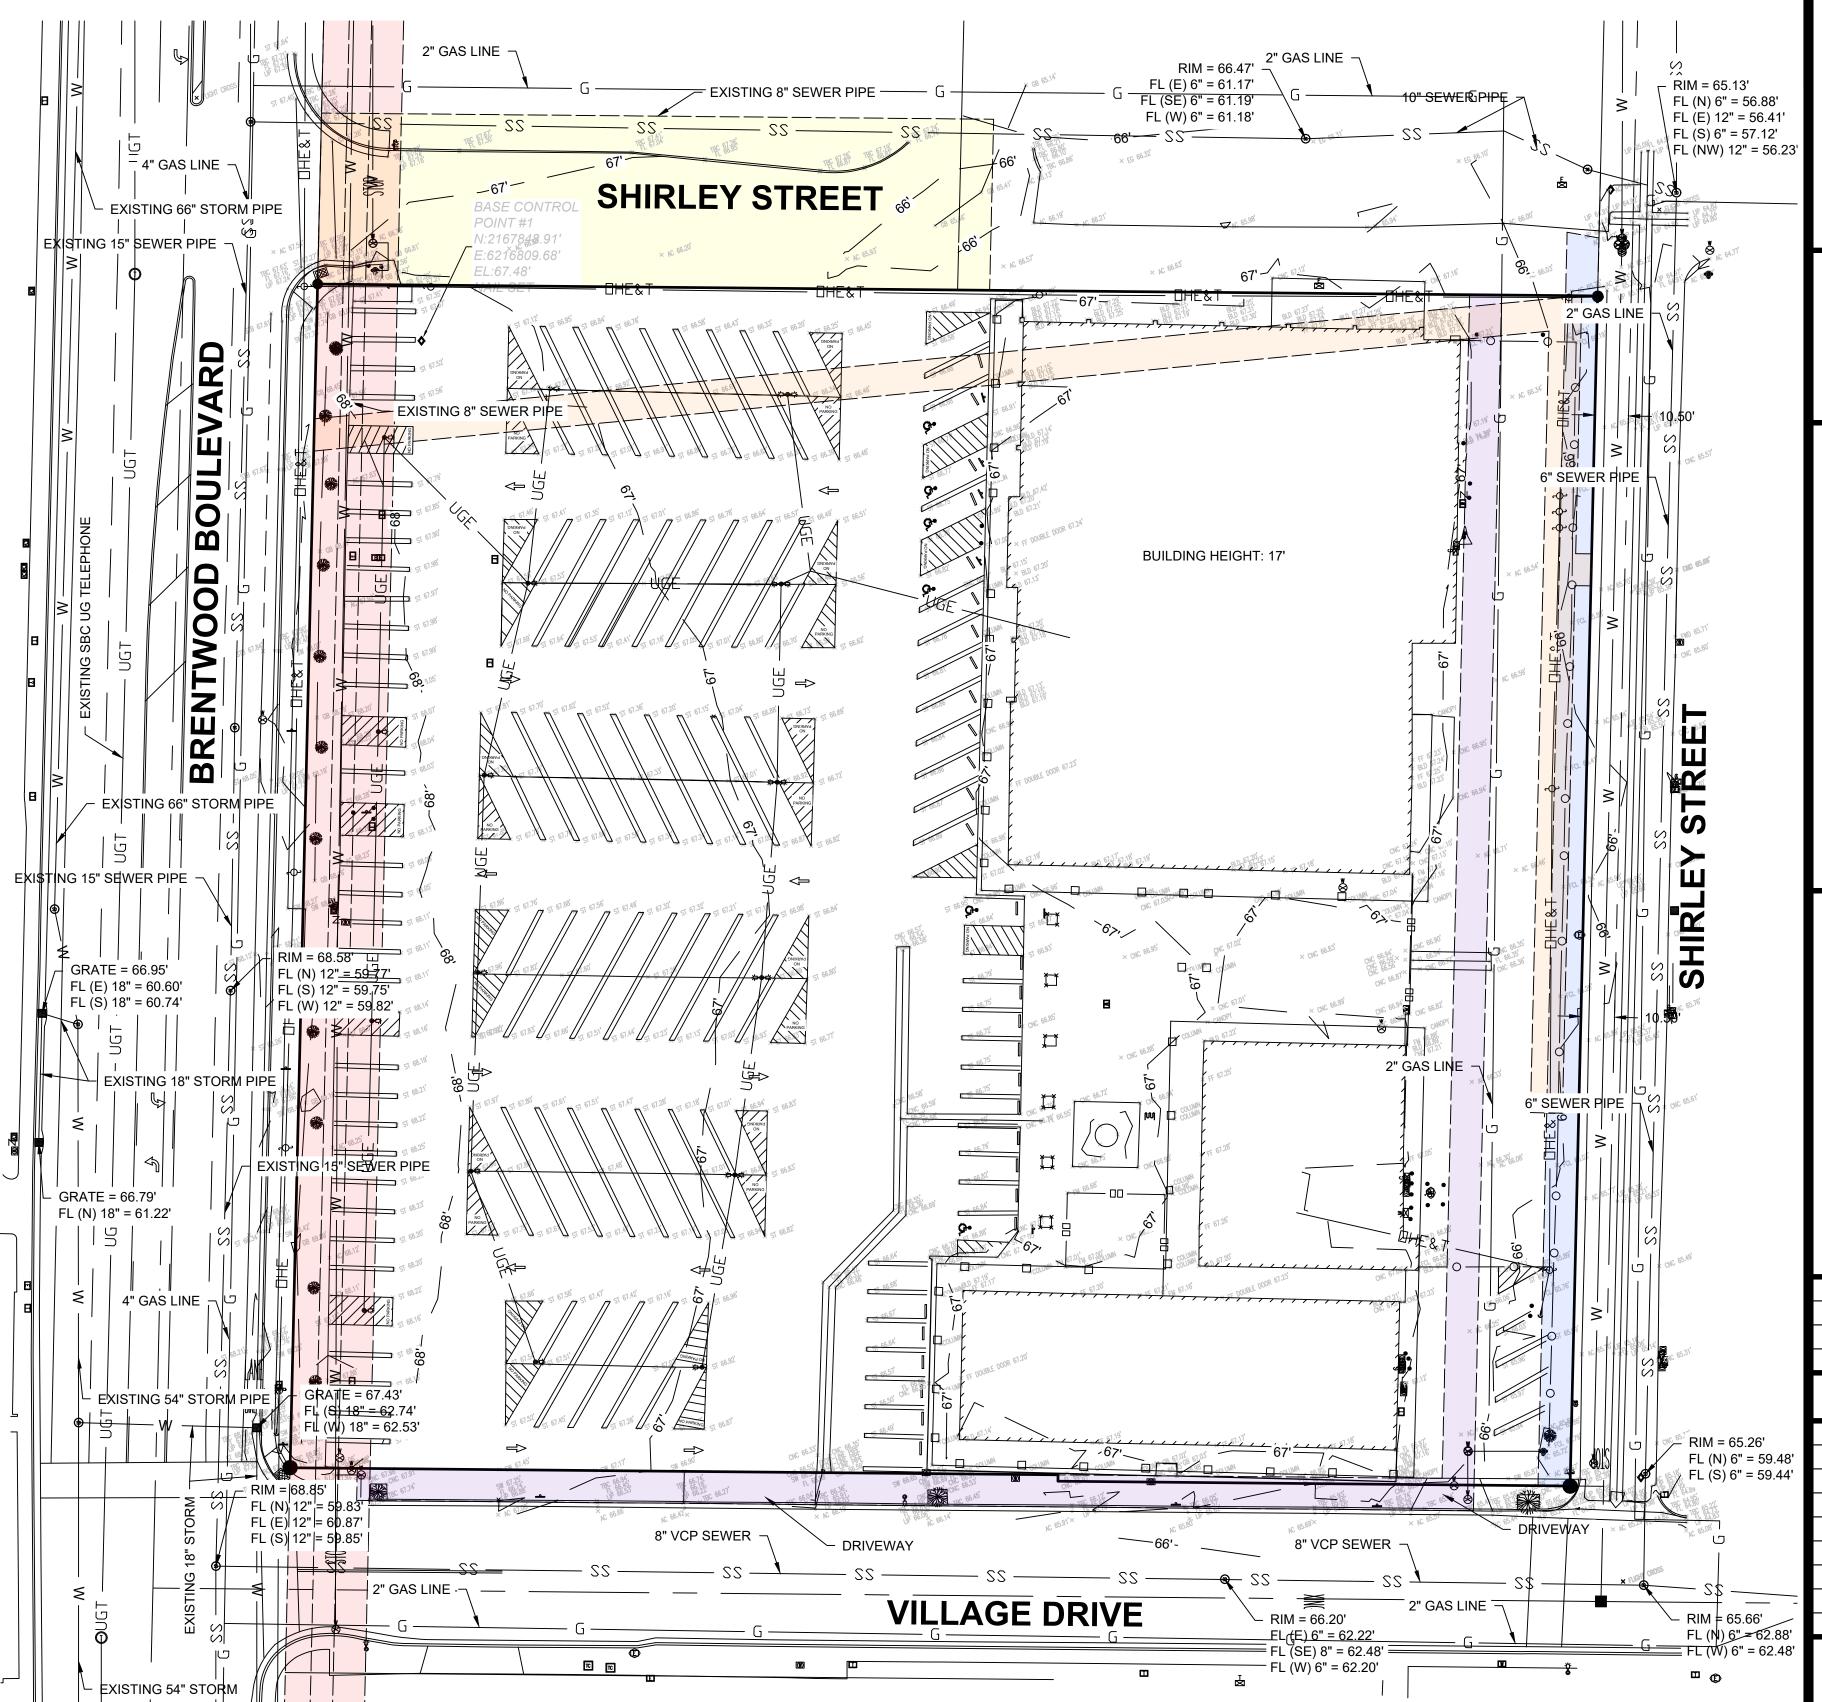




PREPARED BY:

ALTA/NSPS LAND TITLE SURVEY PREPARED FOR:

CLIENT

7820 BRETNWOOD BLVD BRENTWOOD, CA, 94513

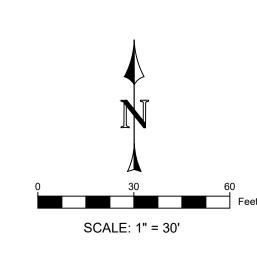

# PROJECT INFO:

PROJECT NO.	23020
DRAWN BY:	NET
CHECKED BY:	NET
DATE:	03/15/2023


# REVISIONS:


DATE	DESC.
03/15/2023	ORIGINAL ISSUE



TOPO SHEET

1 OF 2

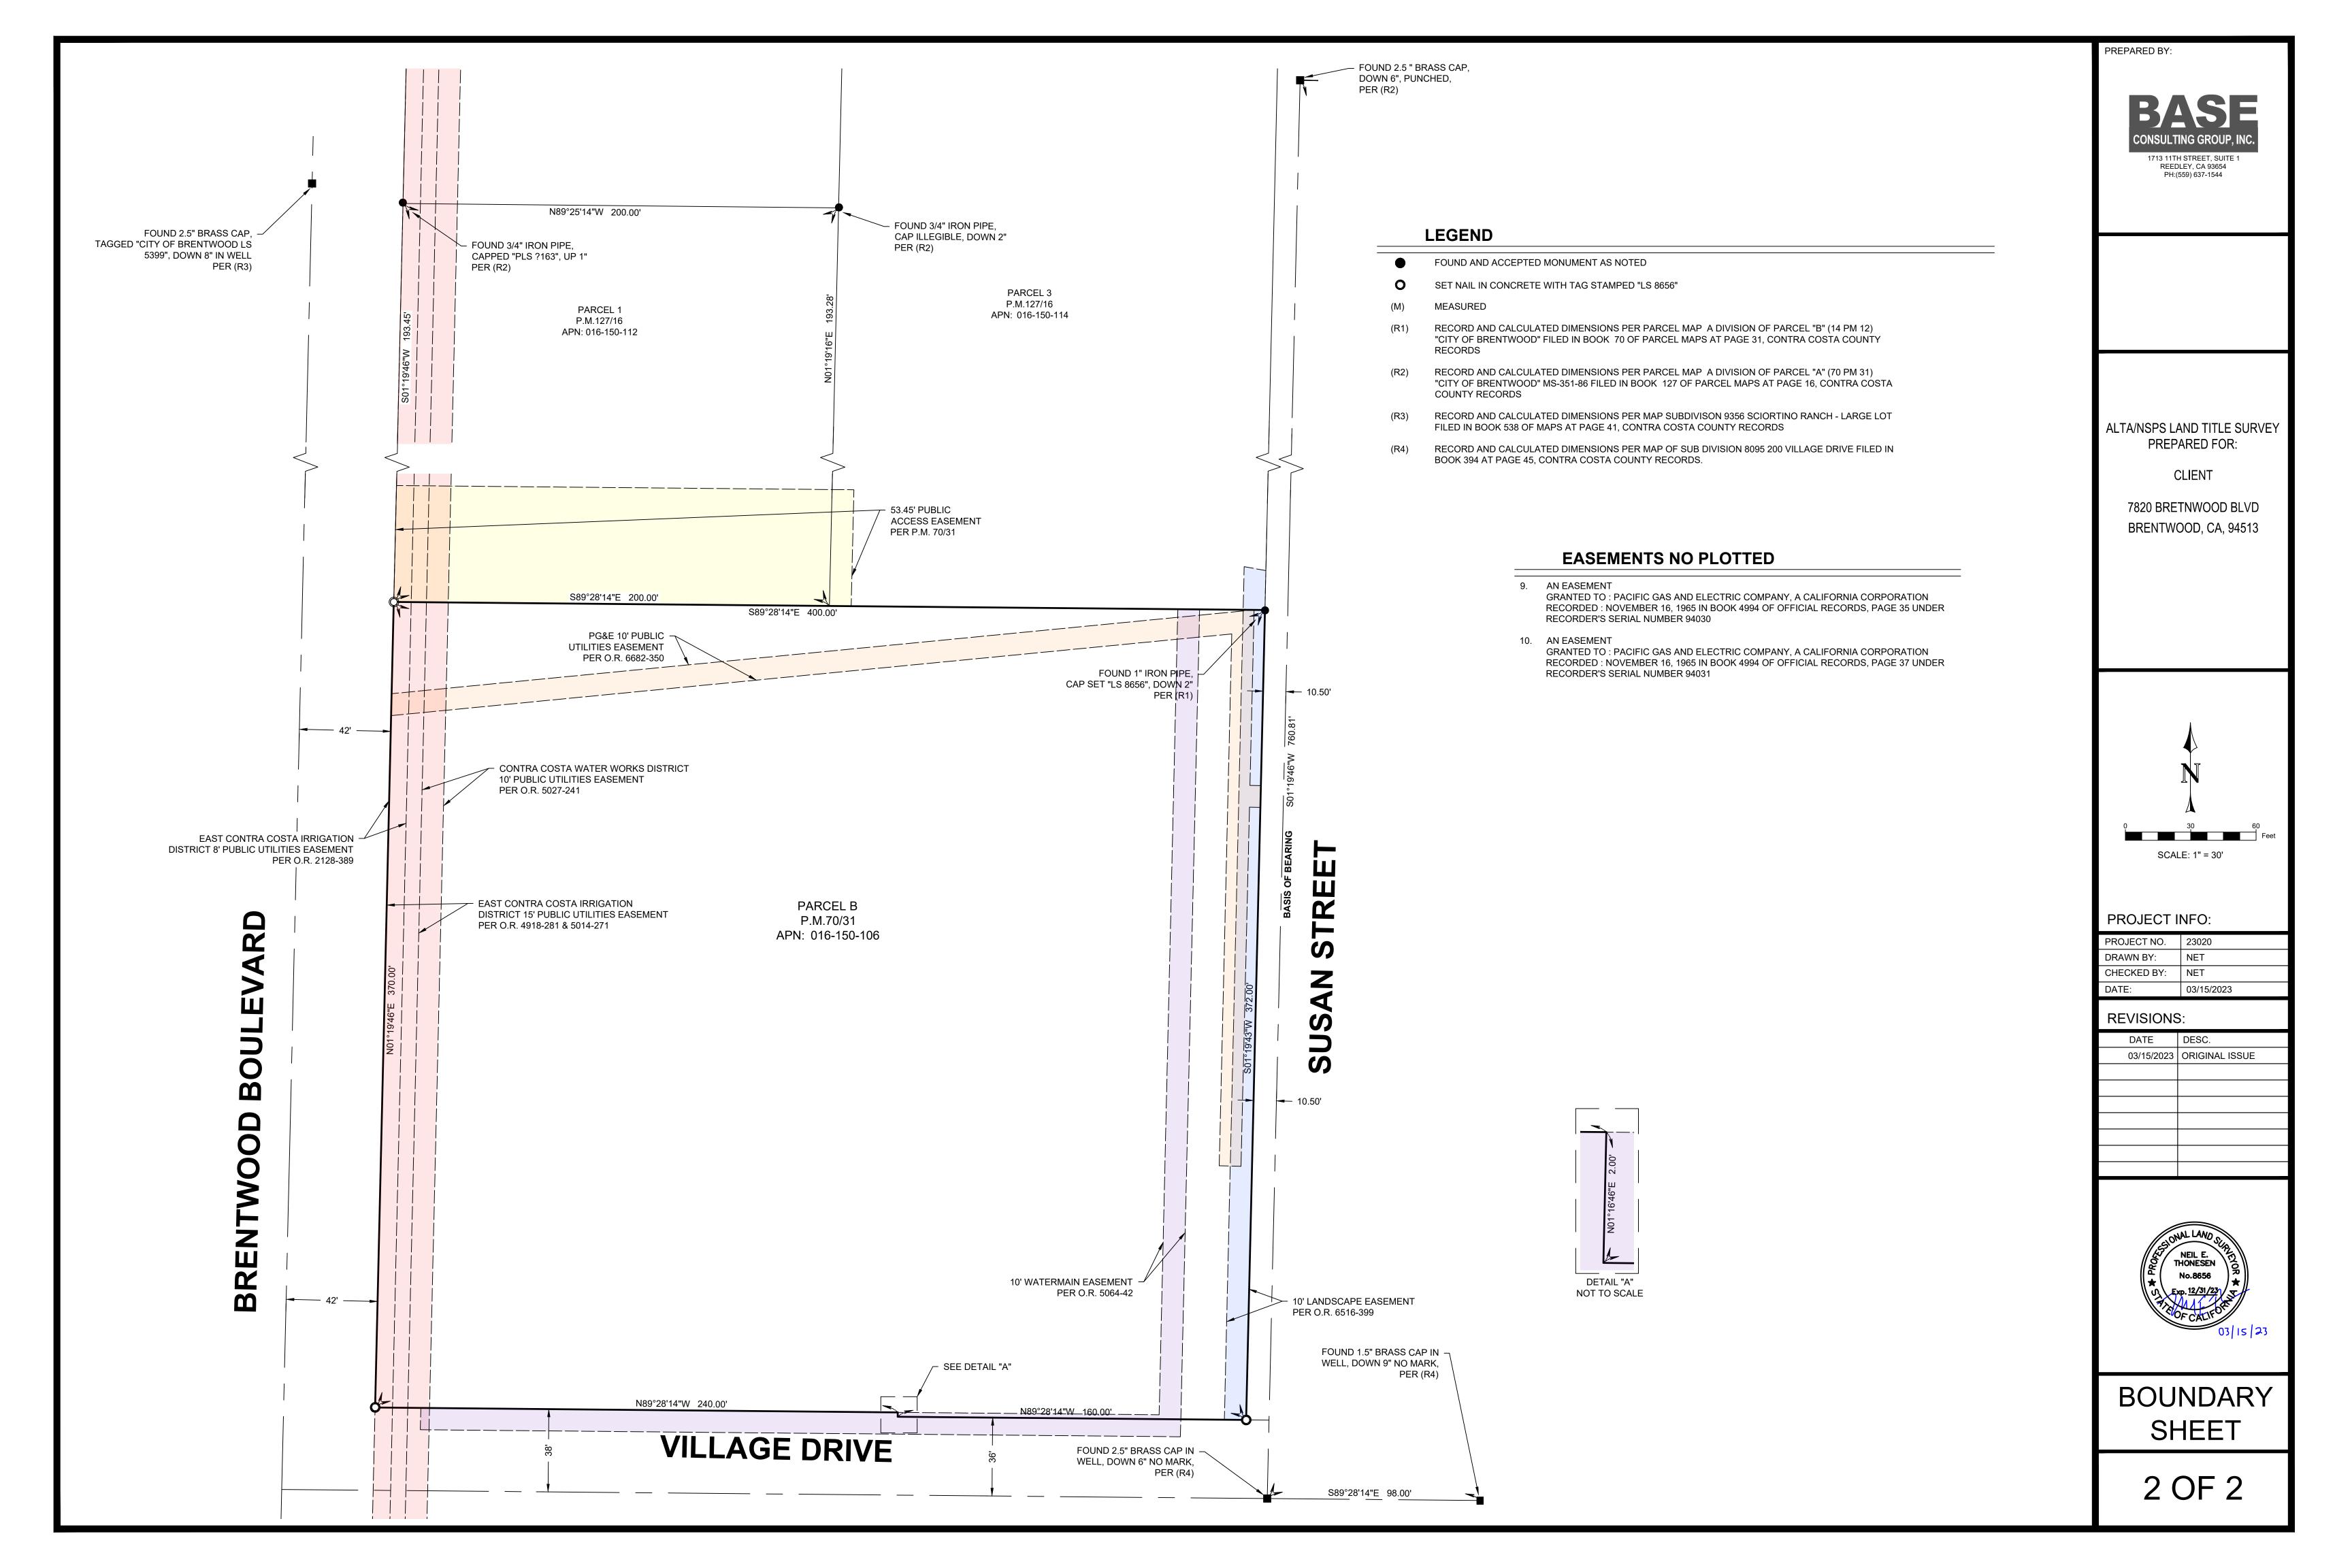

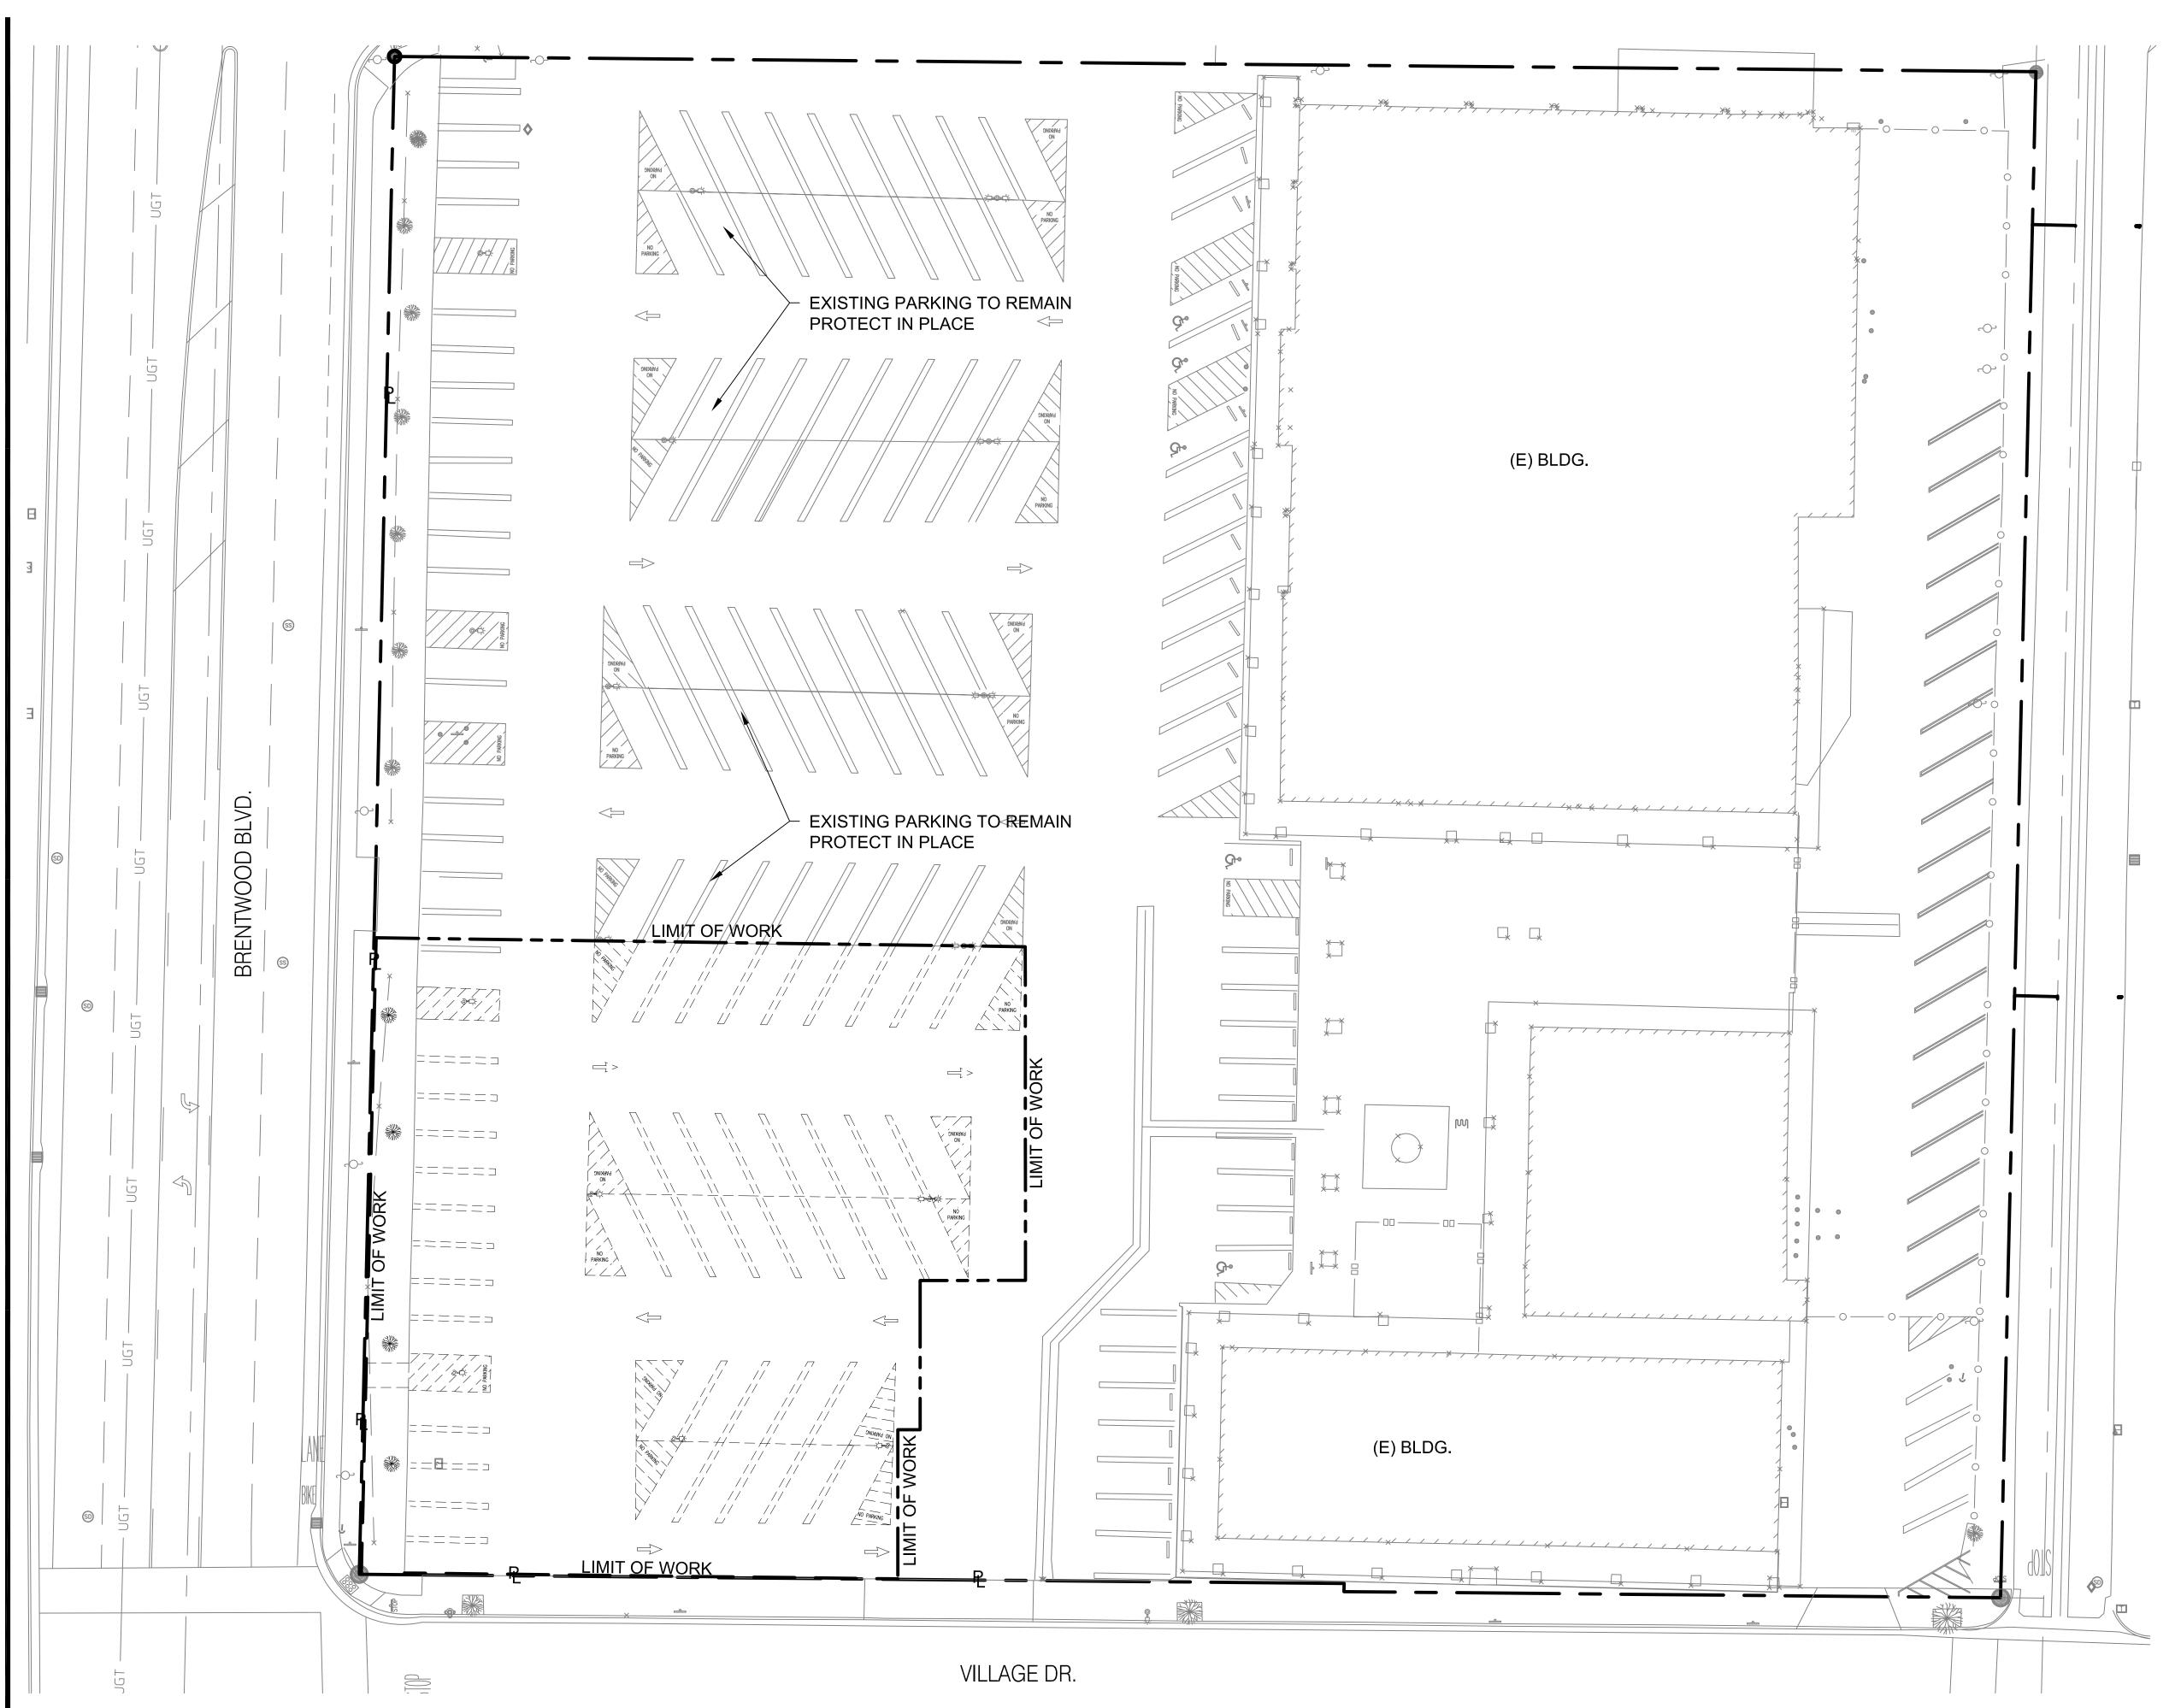



CLIENT: SUNNY GHAI
GHAI MANAGEMENT SERVICES, INC.
25 E. AIRWAY BLVD.
LIVERMORE CA
T: 510.573.5905

E: SUNNY@GHAIMANAGEMENT.COM

Existing Stalls	
(E) stalls getting demo'd	50
(E) Accessible stalls	5
(E) Center stalls	63
(E) Perimeter stalls	48
(E) Stalls behind bldg	23
Total existing	189


ADDRESS: BRENTWOOD BLVD. BRENTWOOD CA, 94513

ASSESSORS #: 016-150-106-9 ZONING: BBSP LOT SIZE: 3.4 ACRES

POPEYES

PROPOSED
OVERALL
SITE PLAN
DEMOLITION



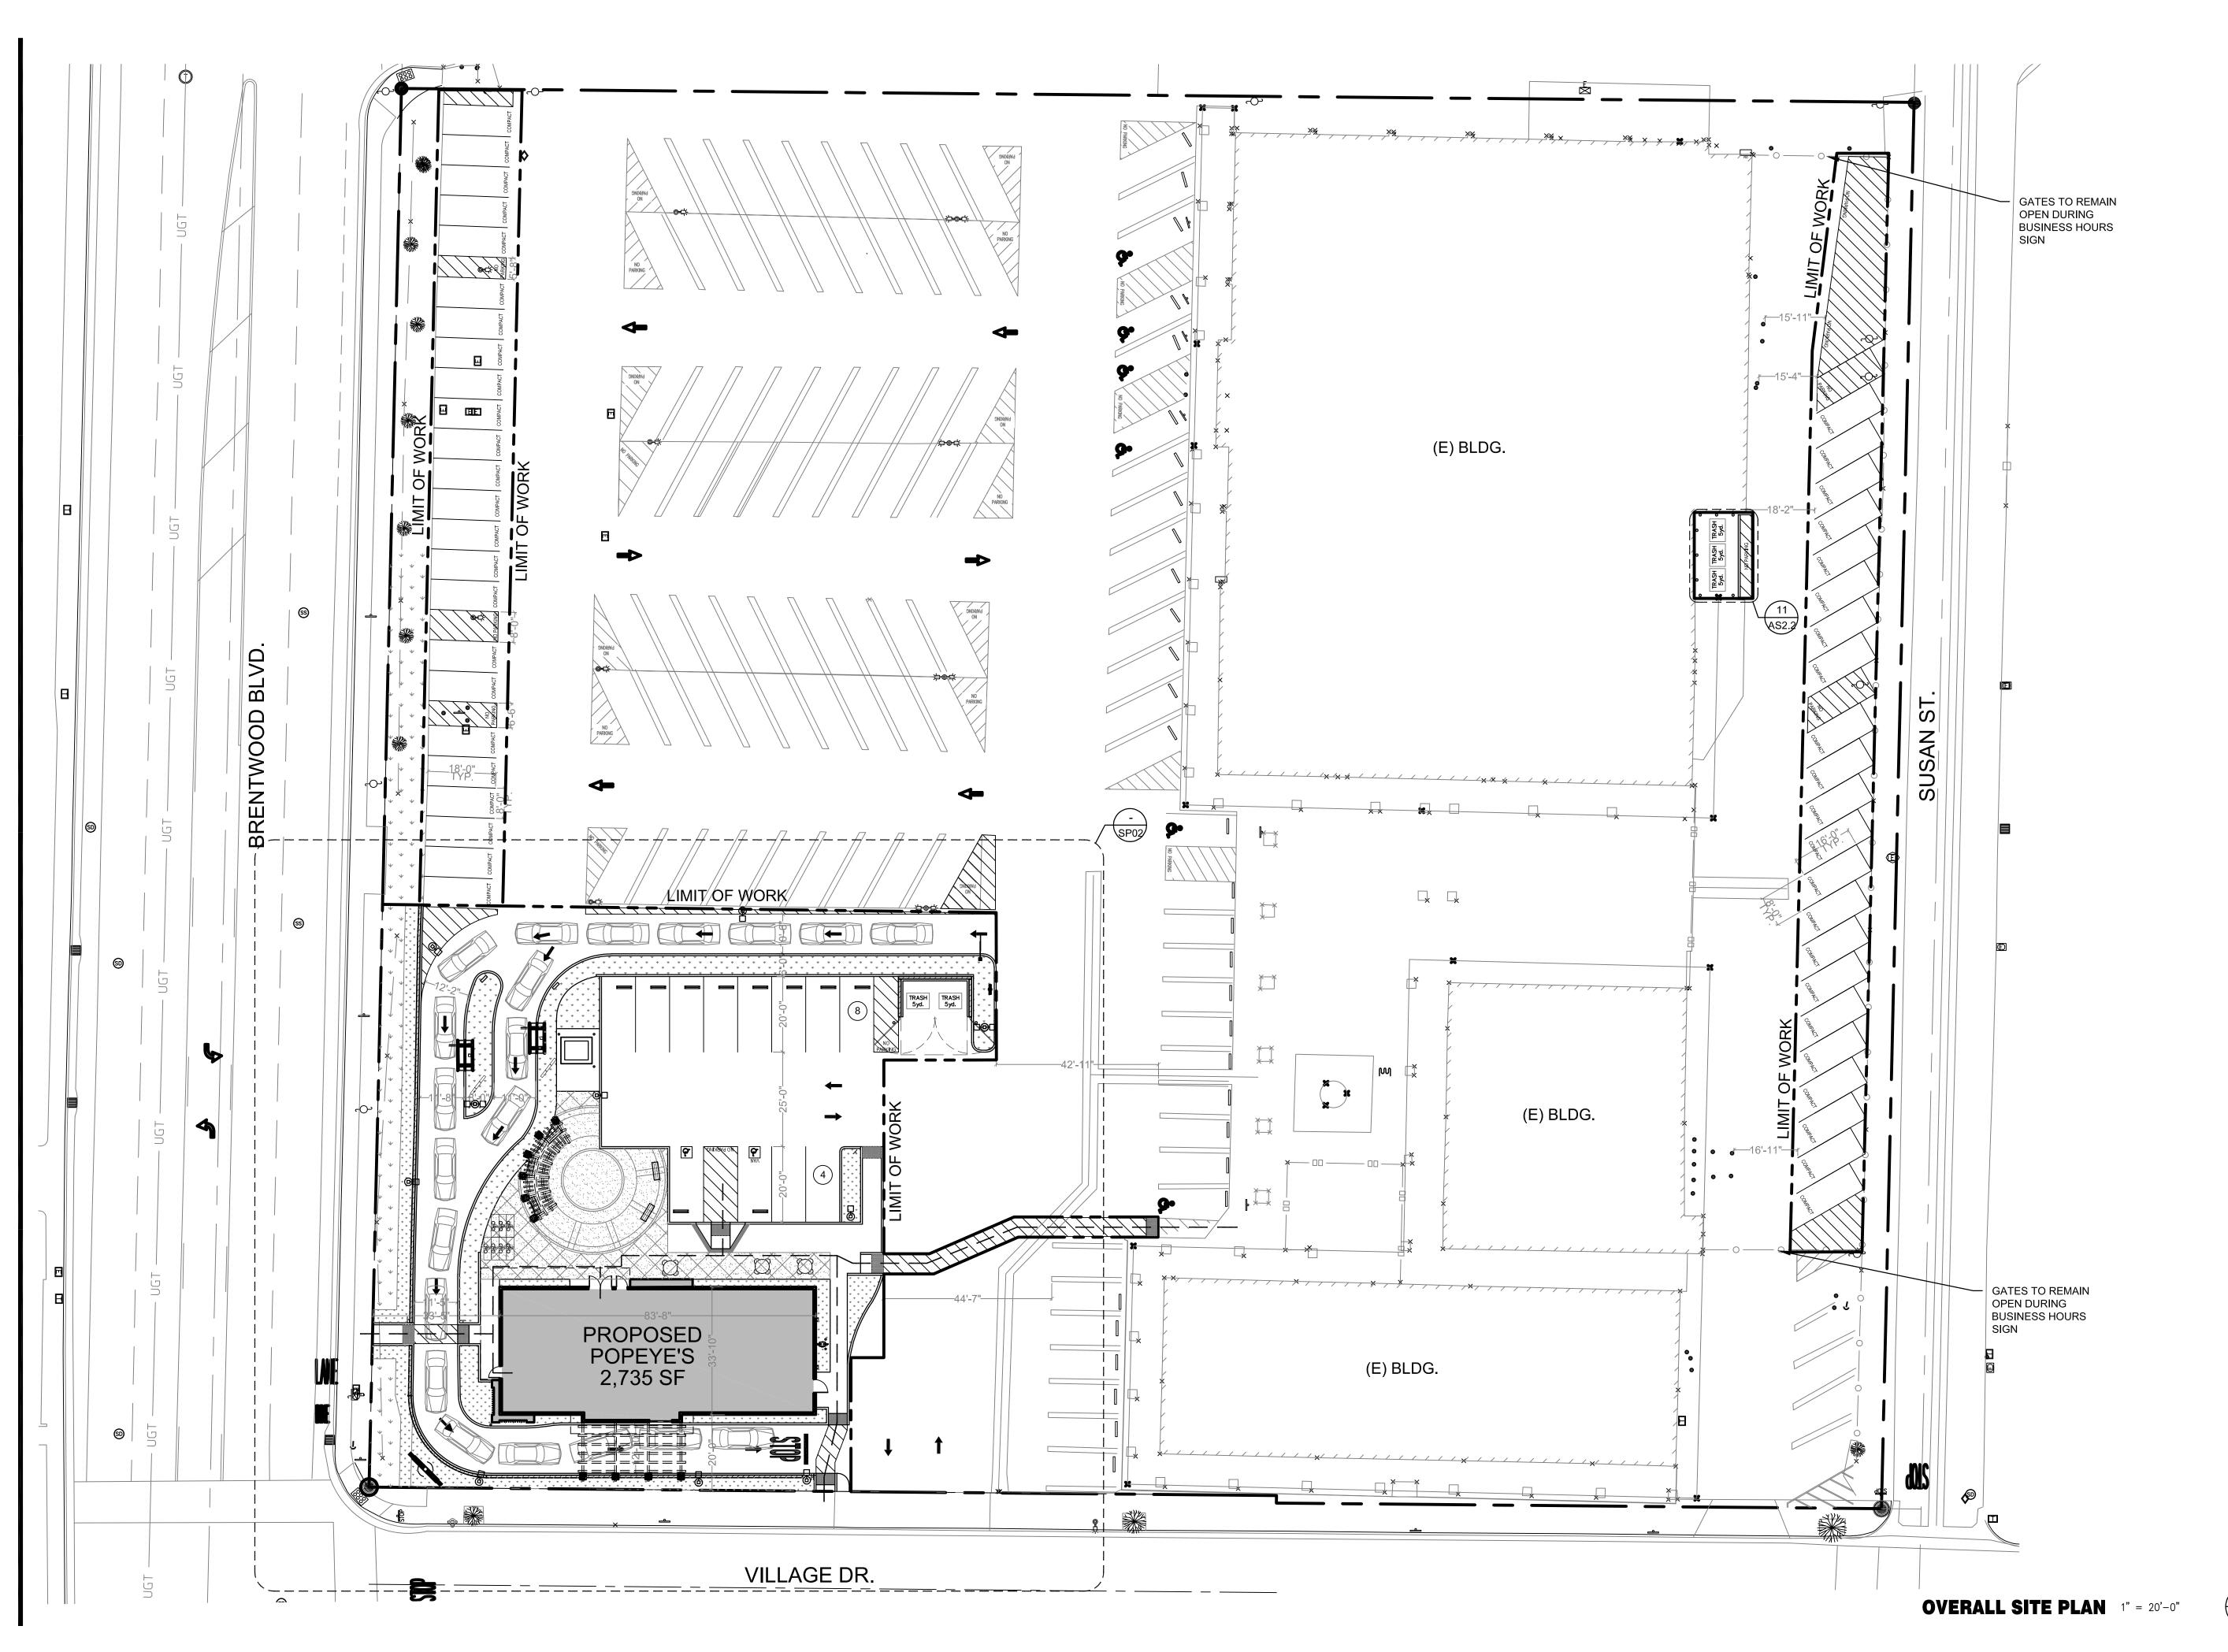



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New Popeys w/ Existing strip	pping
New proposed stalls at popeyes	10
New proposed Accessible stalls	2
New proposed compact stalls at	
Brentowood Blvd.	24
New proposed compact stalls at	
Susan St.	22
(E) In-back side of bldgs.	4
(E) Accessible stalls	6
(E) Center stalls	63
(E) In-front of bldgs.	26
Total	157

# LEGEND:

— — PATH OF TRAVEL

IMPROVEMENT AREA: 21,135 SF

COMMON AREA:

2000 05

TOTAL PARKING STALLS:

10 STANDARD STALLS 2 ACCESSIBLE STALLS


ADDRESS: BRENTWOOD BLVD. BRENTWOOD CA, 94513


ASSESSORS #: 016-150-106-9 ZONING: BBSP LOT SIZE: 3.4 ACRES

POPEYES

PROPOSED OVERALL SITE PLAN SP01



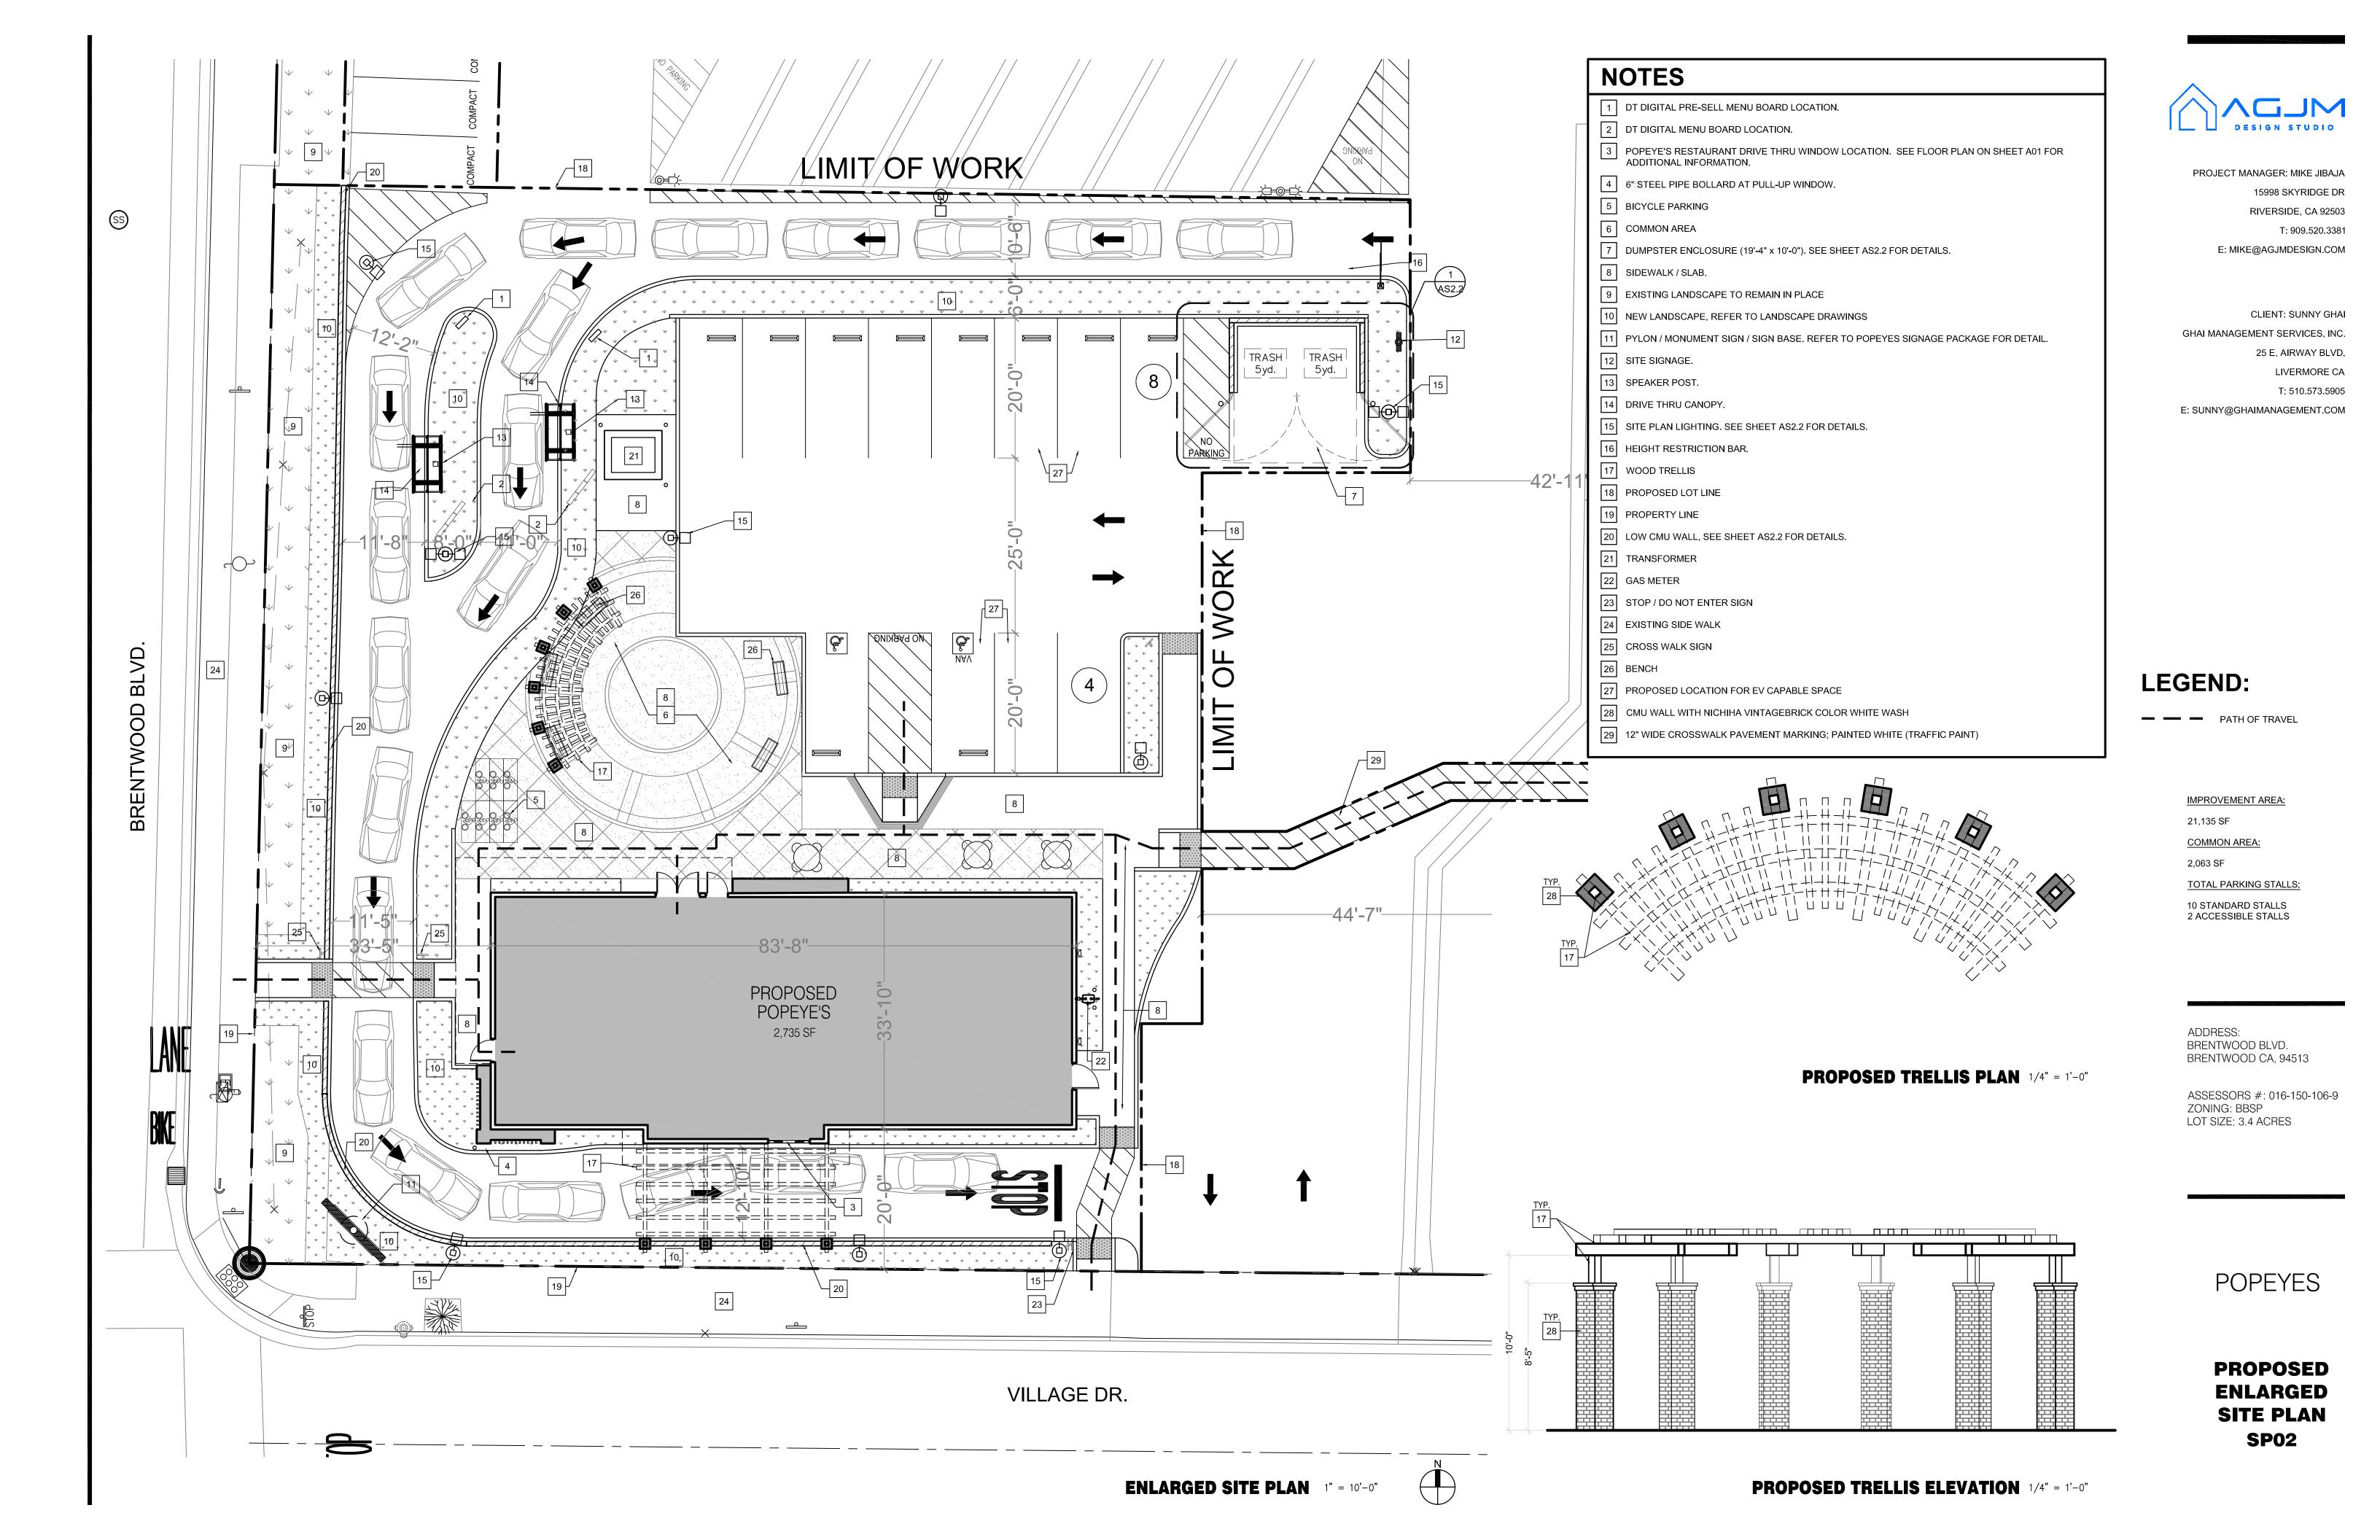

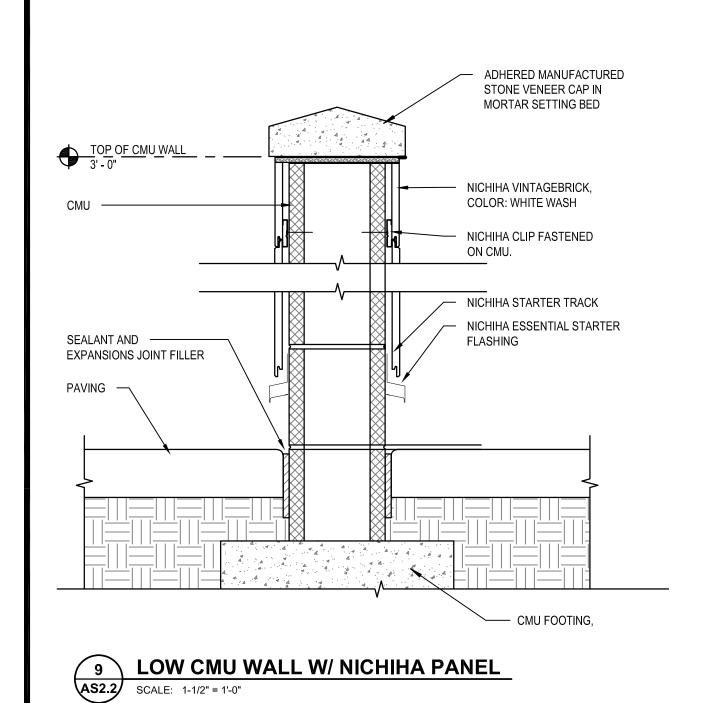

AREA/SITE LIGHTER

Visual comfort standard

(E) CHAIN — LINK FENE

• Low profile LED area/site luminaire with a variety of IES distributions for lighting applications such as retail, commercial and campus parking lots Featuring Micro Strike Optics which maximizes target zone illumination with

• 3G rated for high vibration applications including bridges and overpasses


minimal losses at the house-side, reducing light trespass issues

Compact and lightweight design with low EPA


Intelligence™ and 7-Pin with networked controls

Best in class surge protection available


**FEATURES** 

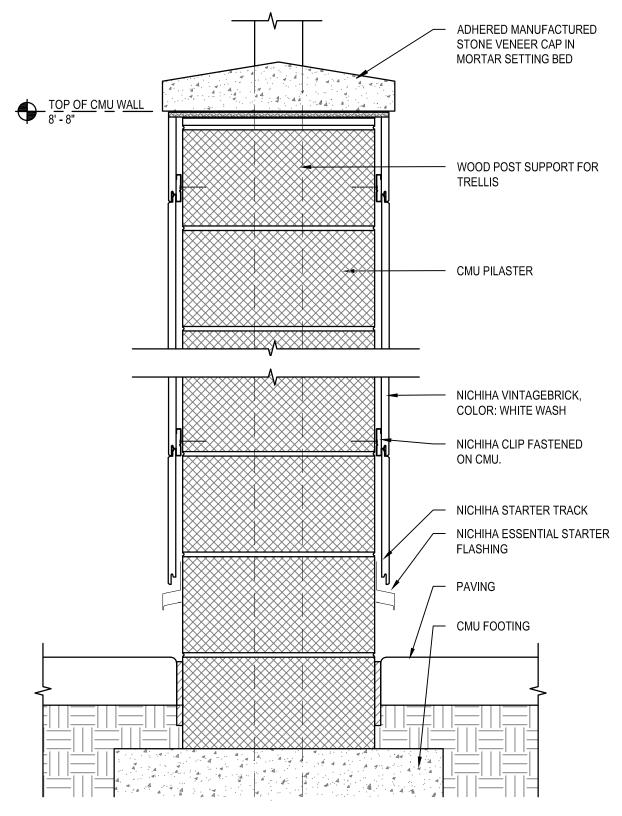




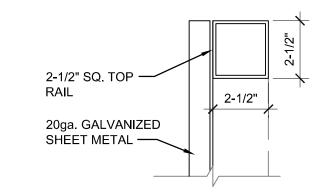



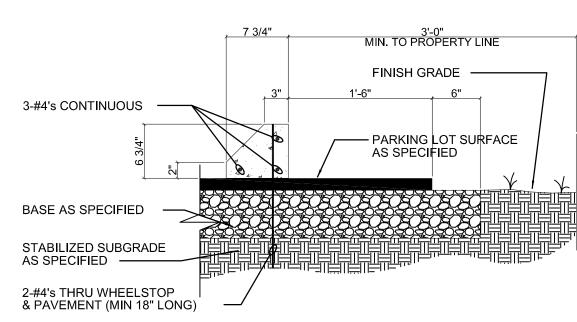

7 WHEELSTOP (PRECAST) **AS2.2** SCALE: 1" = 1'-0"

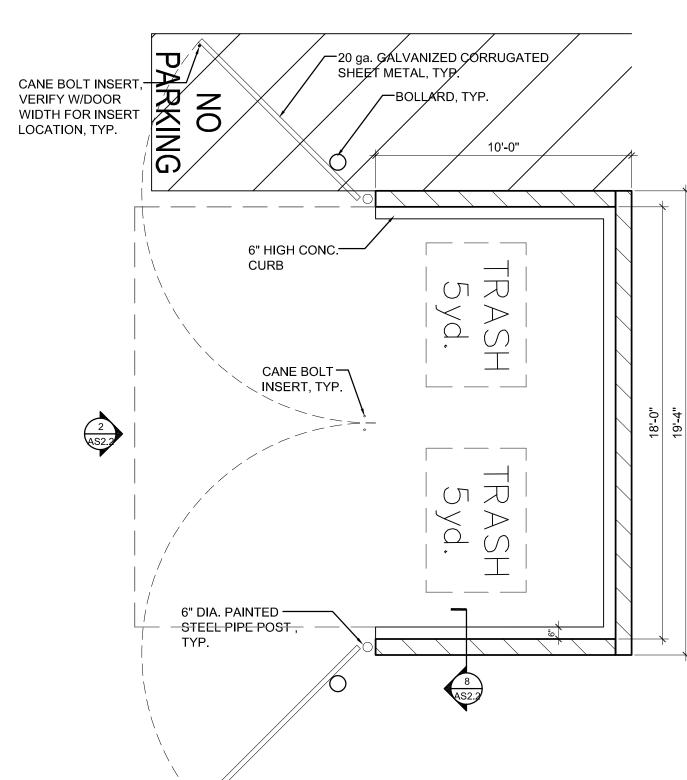





RIVERSIDE, CA 92503 T: 909.520.3381 E: MIKE@AGJMDESIGN.COM

CLIENT: SUNNY GHAI GHAI MANAGEMENT SERVICES, INC. 25 E. AIRWAY BLVD. LIVERMORE CA T: 510.573.5905 E: SUNNY@GHAIMANAGEMENT.COM

# DUMPSTER ENCLOSURE - POPEYES

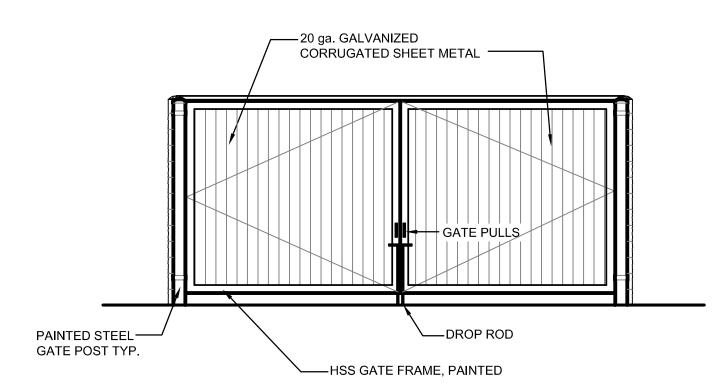

# DUMPSTER ENCLOSURE & GATE EXT. ELEV. **AS2.2** SCALE: 1/4" = 1'-0"

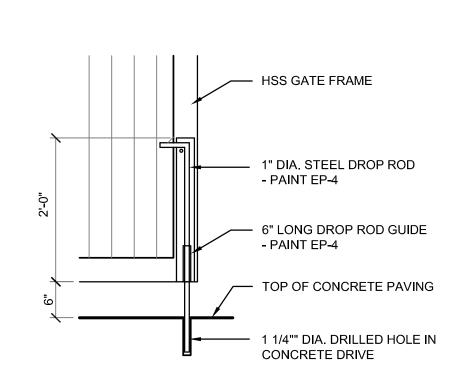

ADDRESS: BRENTWOOD BLVD. BRENTWOOD CA, 94513

ASSESSORS #: 016-150-106-9 ZONING: BBSP LOT SIZE: 3.4 ACRES

POPEYES

SITE DETAILS **TRASH ENCLOSURE AS2.2** 



←BOND BEAM

COURSE W/

32" O.C.

16" O.C.

AGG. BASE

SLOPE 1/4"

1'-4"

PER FT

8" THICK POUR-IN

PLACE SLAB W/ 6"x6" -


10/10 W.W.M. ON 6"


- HORIZ. REINF.

(1) #5 CONT., GROUT

SOLID 8" CMU W/ #5

VERTICAL REBAR @

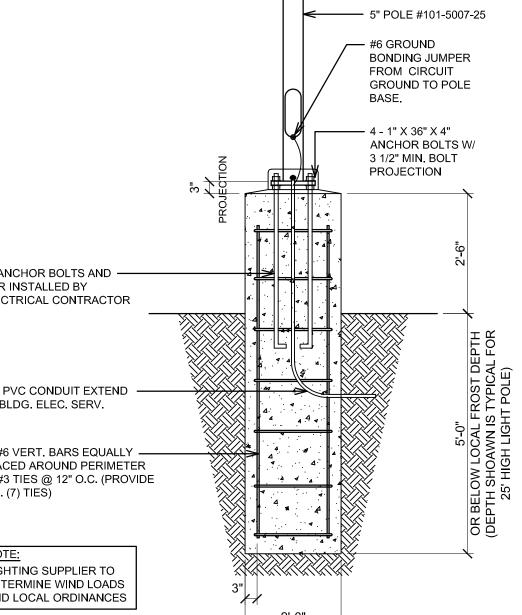

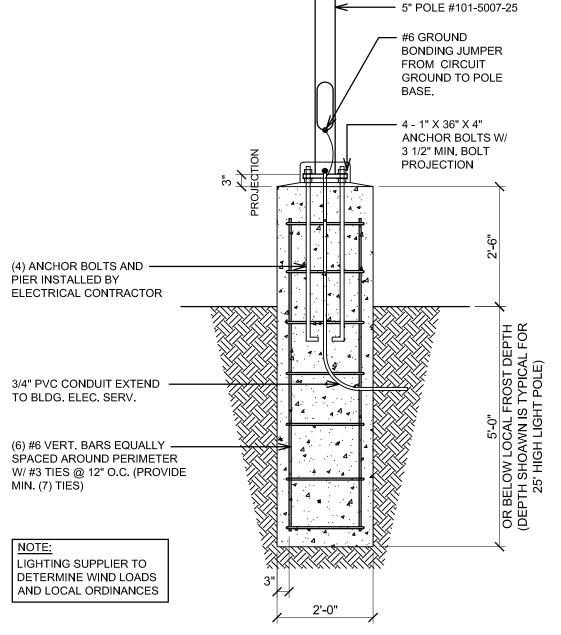





(E) BLDG.

BOLLARD,

CONC. CURB

22'-4"









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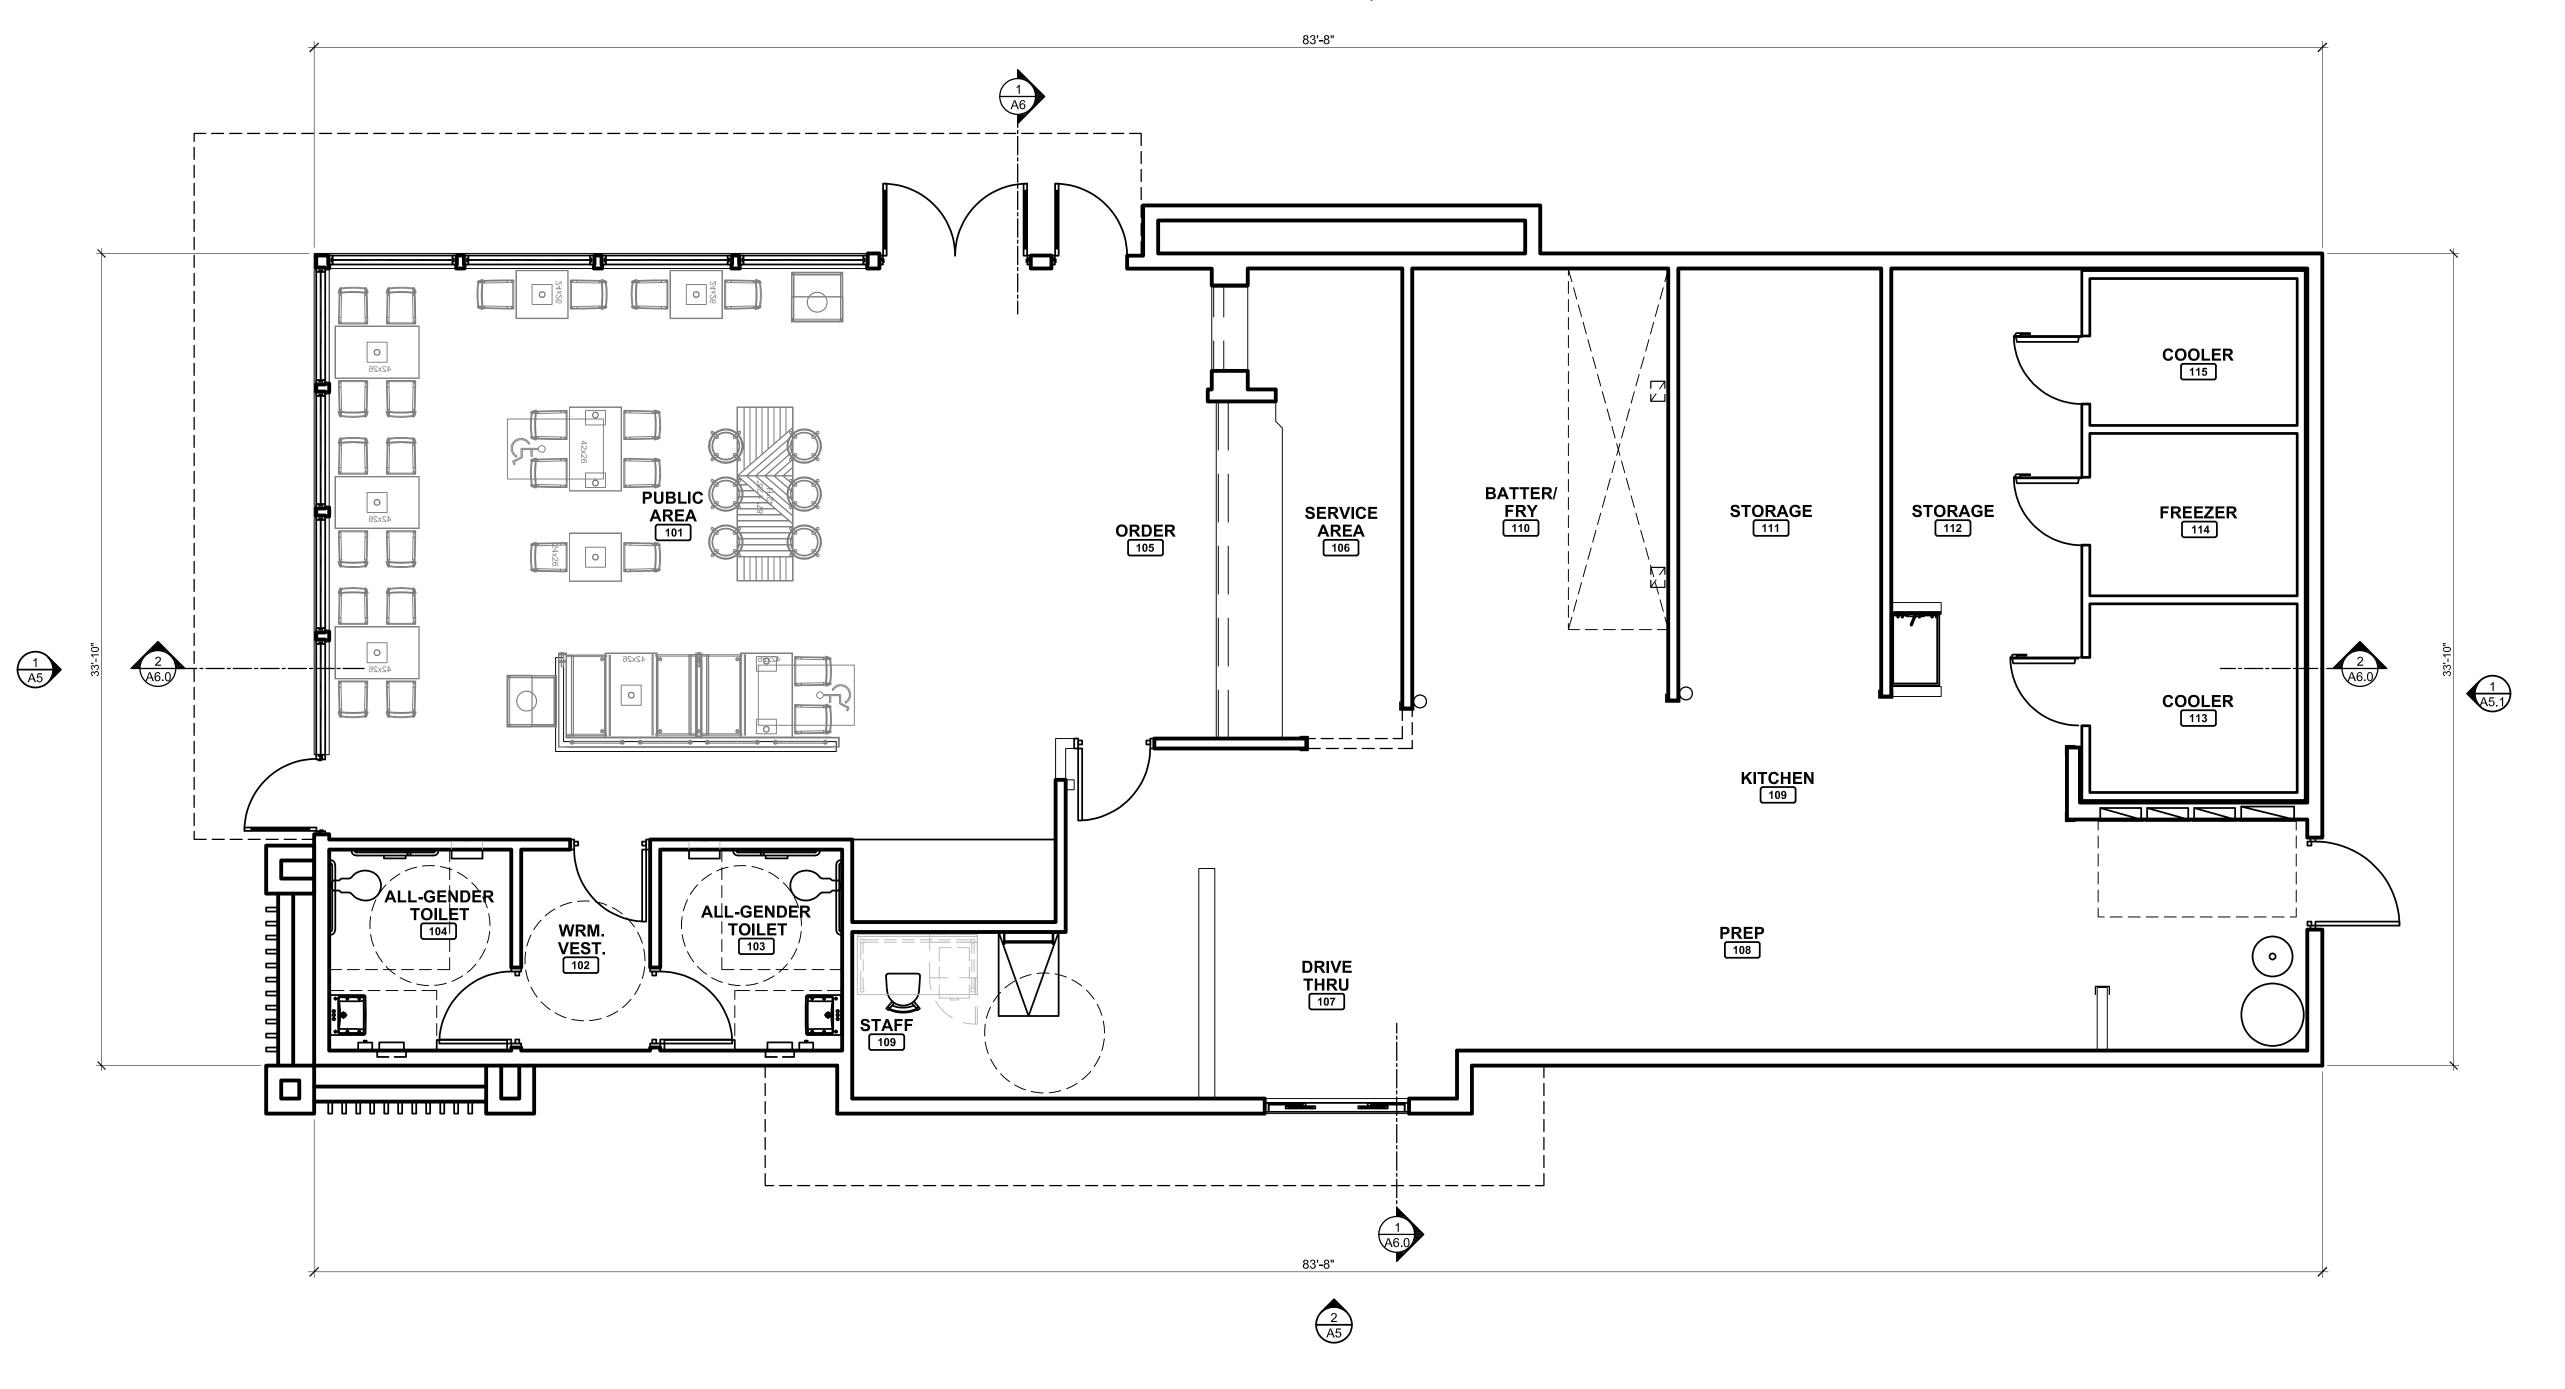
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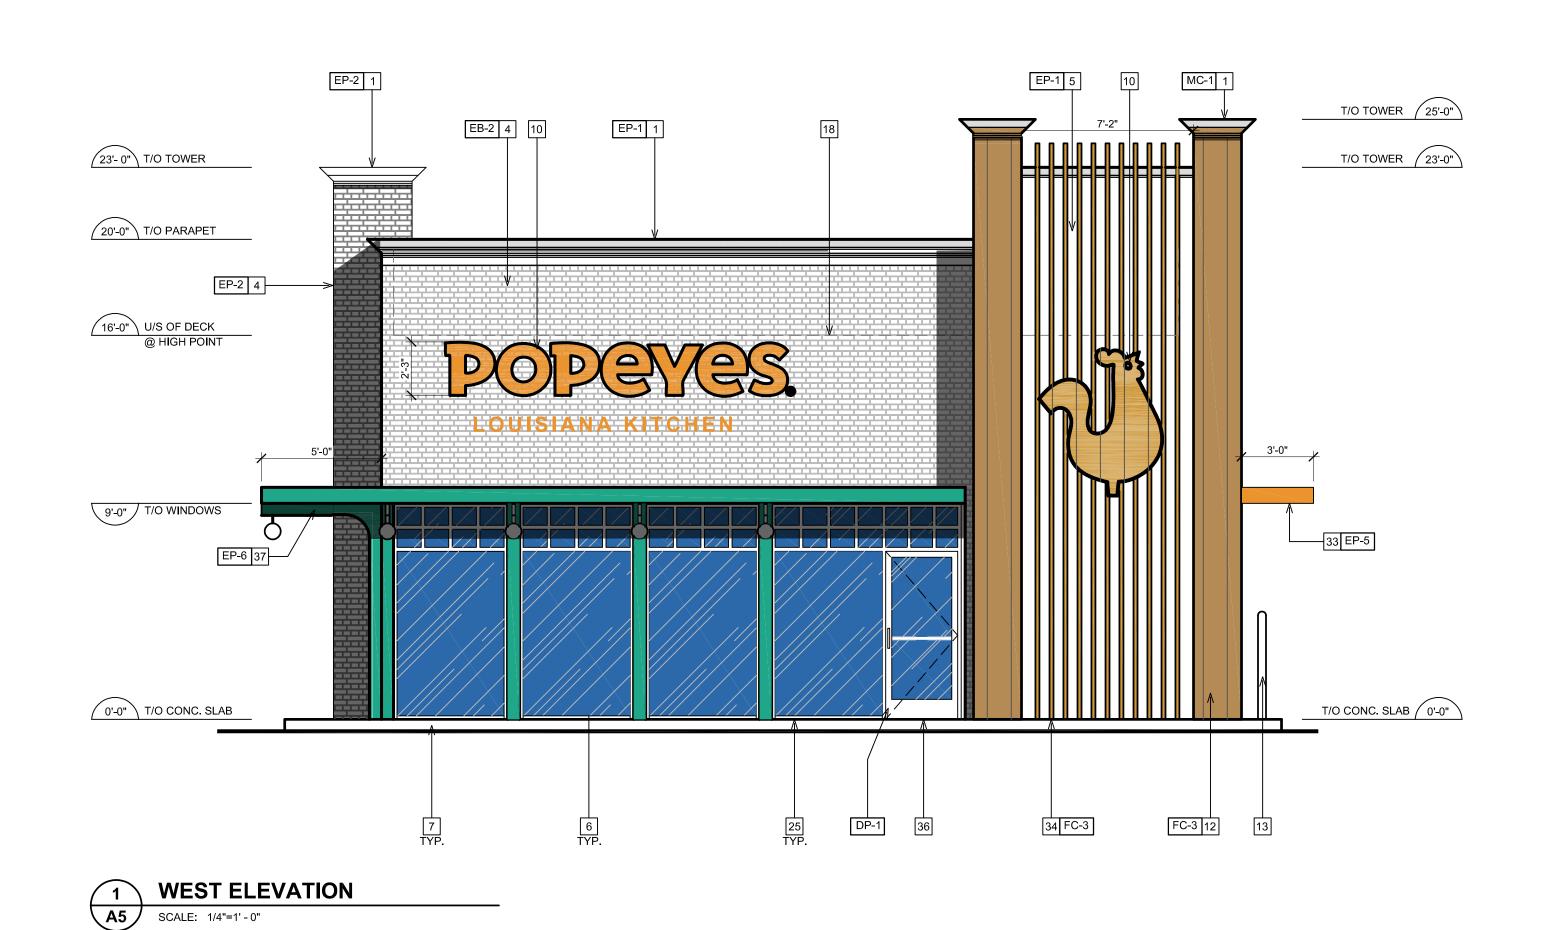
ASSESSORS #: 016-150-106-9 ZONING: BBSP LOT SIZE: 3.4 ACRES


POPEYES

# **PROPOSED FLOOR PLAN**

**A01** 






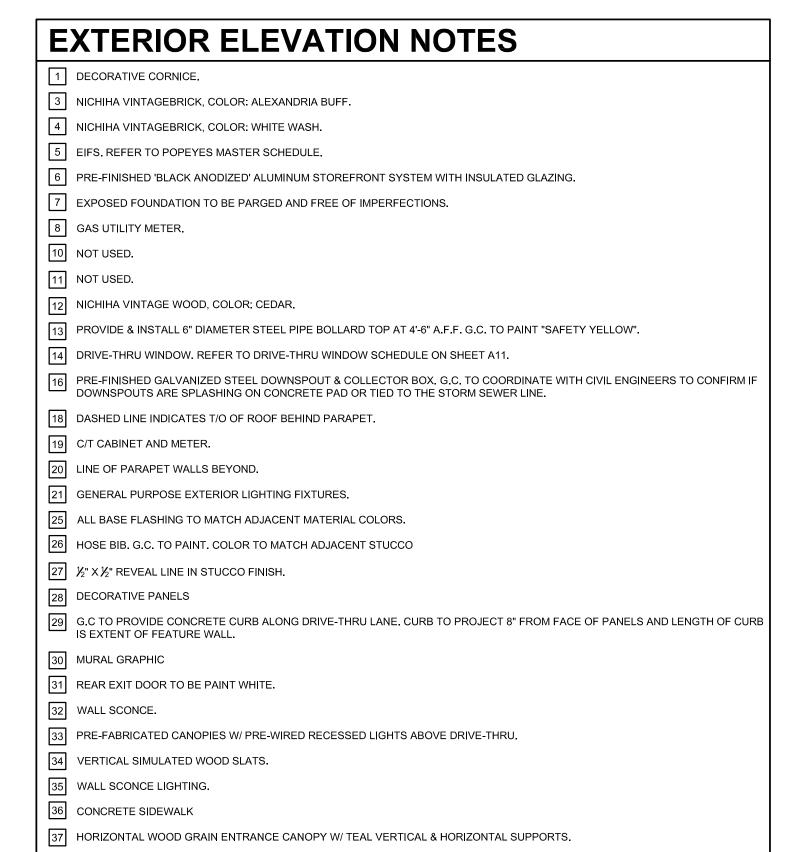



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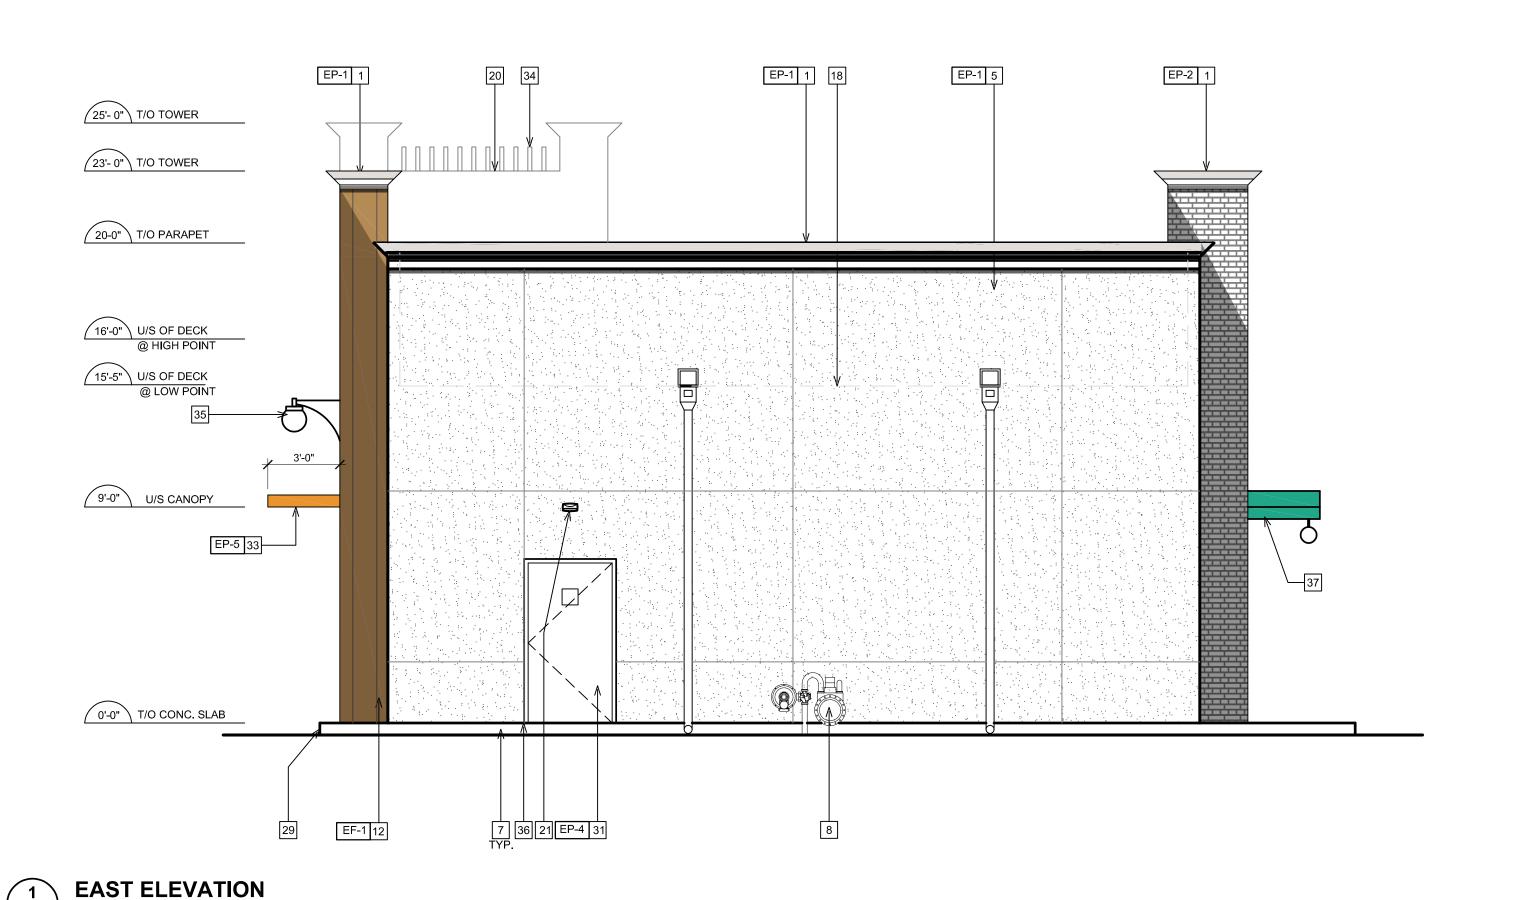
FN#

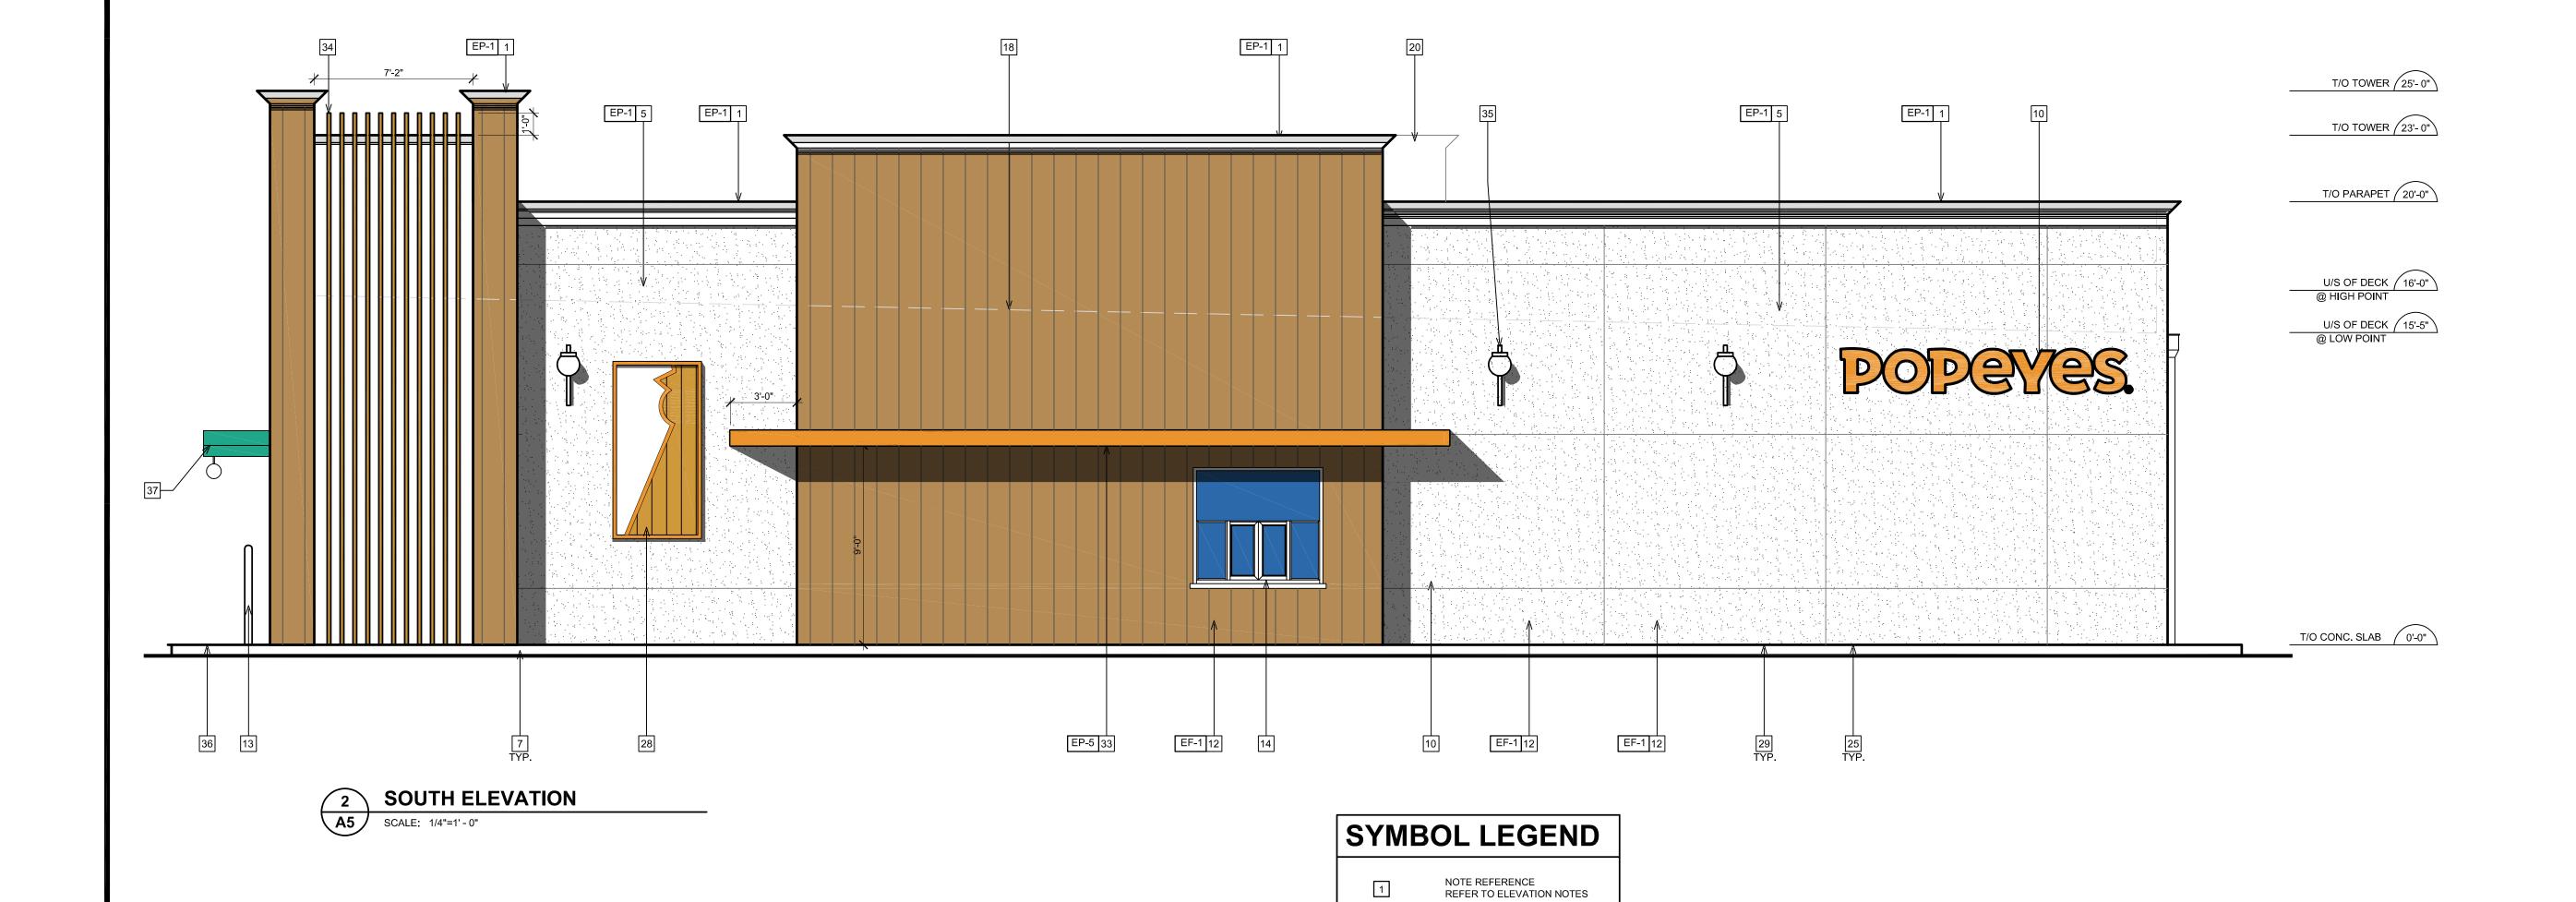ADDRESS: BRENTWOOD BLVD. BRENTWOOD CA, 94513


ASSESSORS #: 016-150-106-9 ZONING: BBSP LOT SIZE: 3.4 ACRES

POPEYES

PROPOSED EXTERIOR ELEVATIONS A5



SCALE: 1/4"=1' - 0"

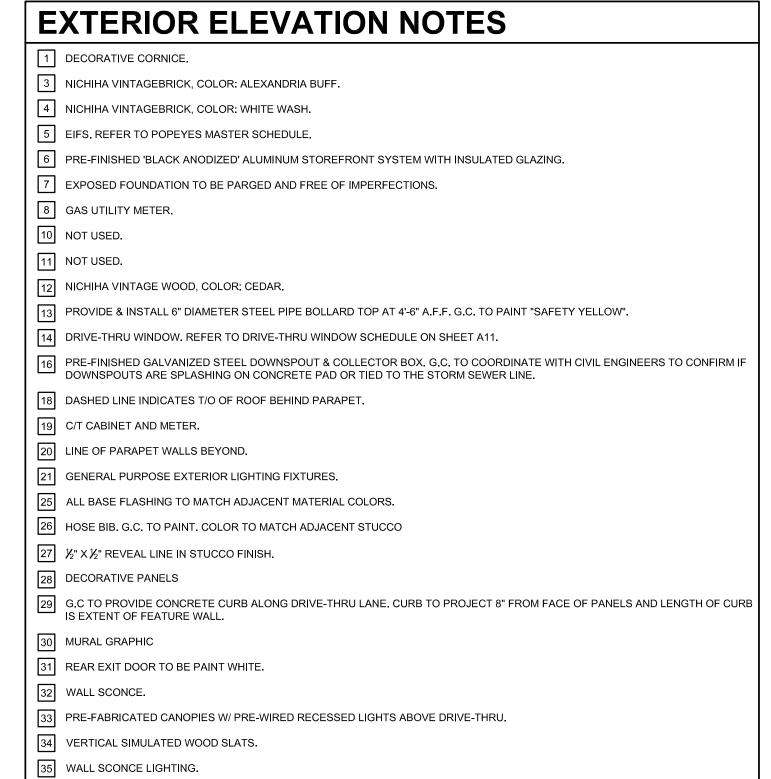

37 HORIZONTAL WOOD GRAIN ENTRANCE CANOPY W/ TEAL VERTICAL & HORIZONTAL SUPPORTS.

36 CONCRETE SIDEWALK



PROJECT MANAGER: MIKE JIBAJA


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NOTE REFERENCE REFER TO ELEVATION NOTES

FINISH TYPE

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ASSESSORS #: 016-150-106-9 ZONING: BBSP LOT SIZE: 3.4 ACRES


POPEYES

PROPOSED EXTERIOR ELEVATIONS A5.1

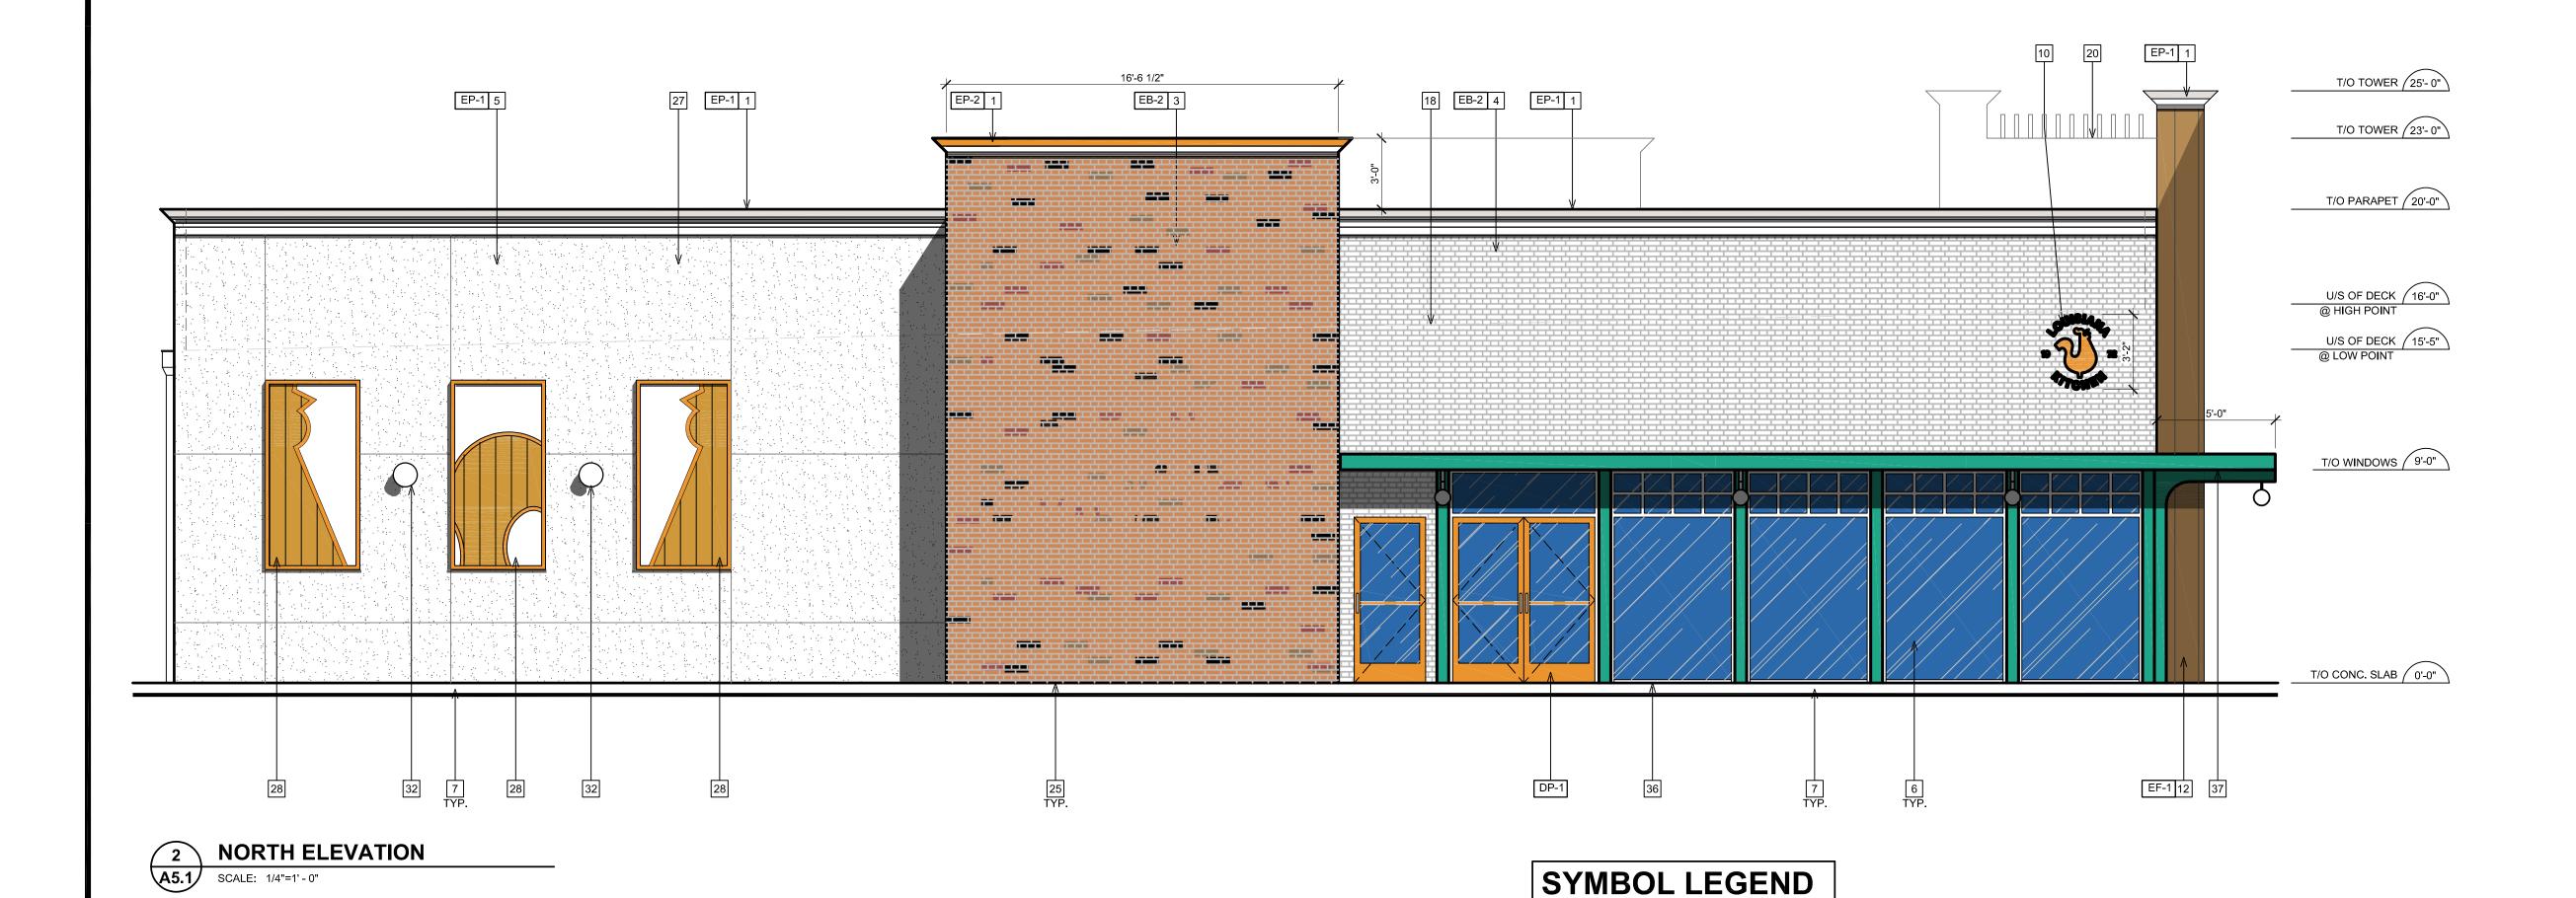


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PROPOSED BUILDING SECTION

A6 SCALE: 1/4" = 1'-0"

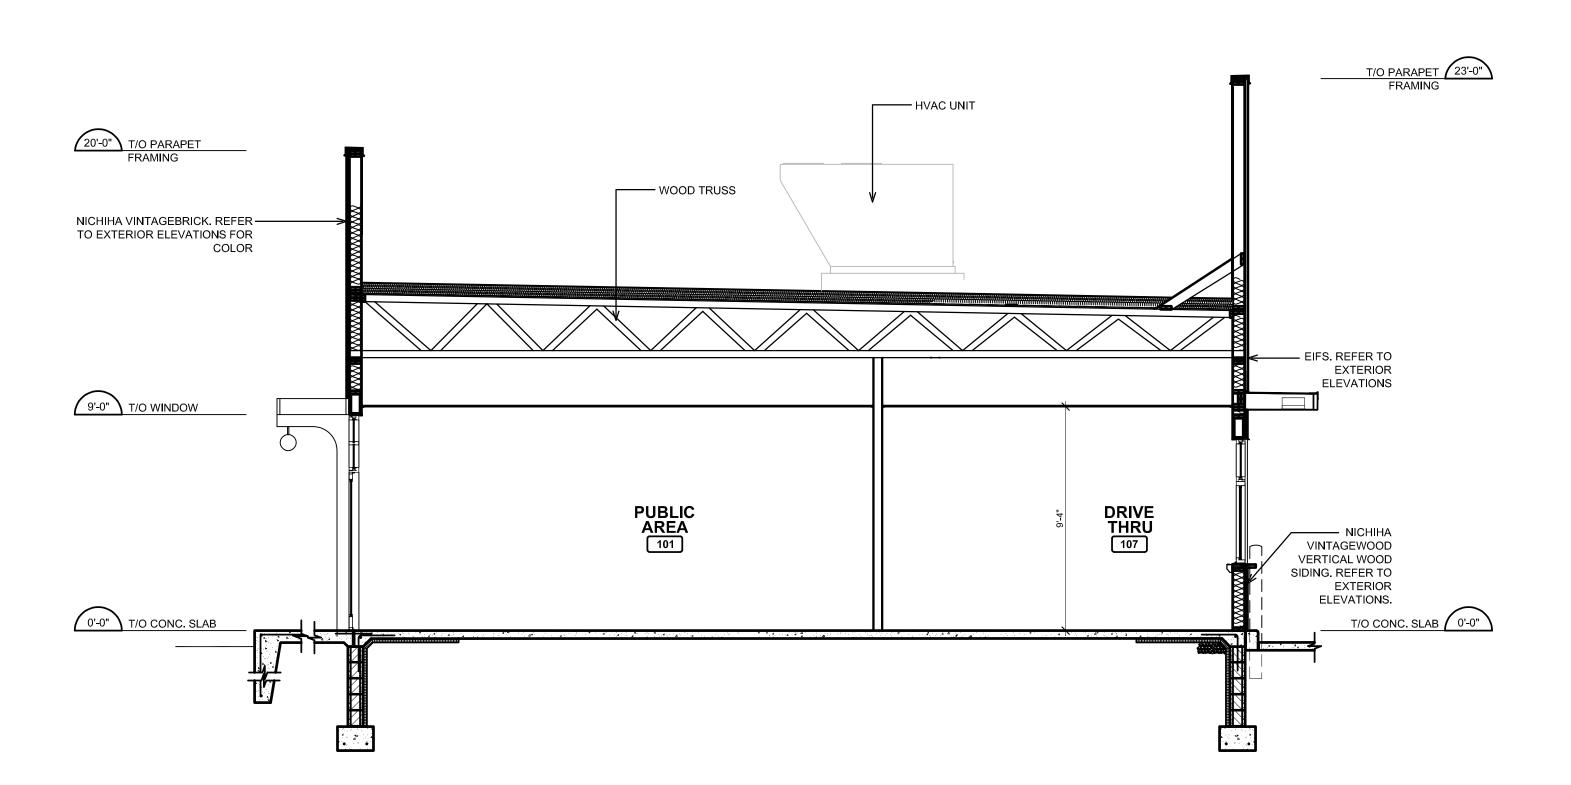

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ASSESSORS #: 016-150-106-9 ZONING: BBSP LOT SIZE: 3.4 ACRES

POPEYES

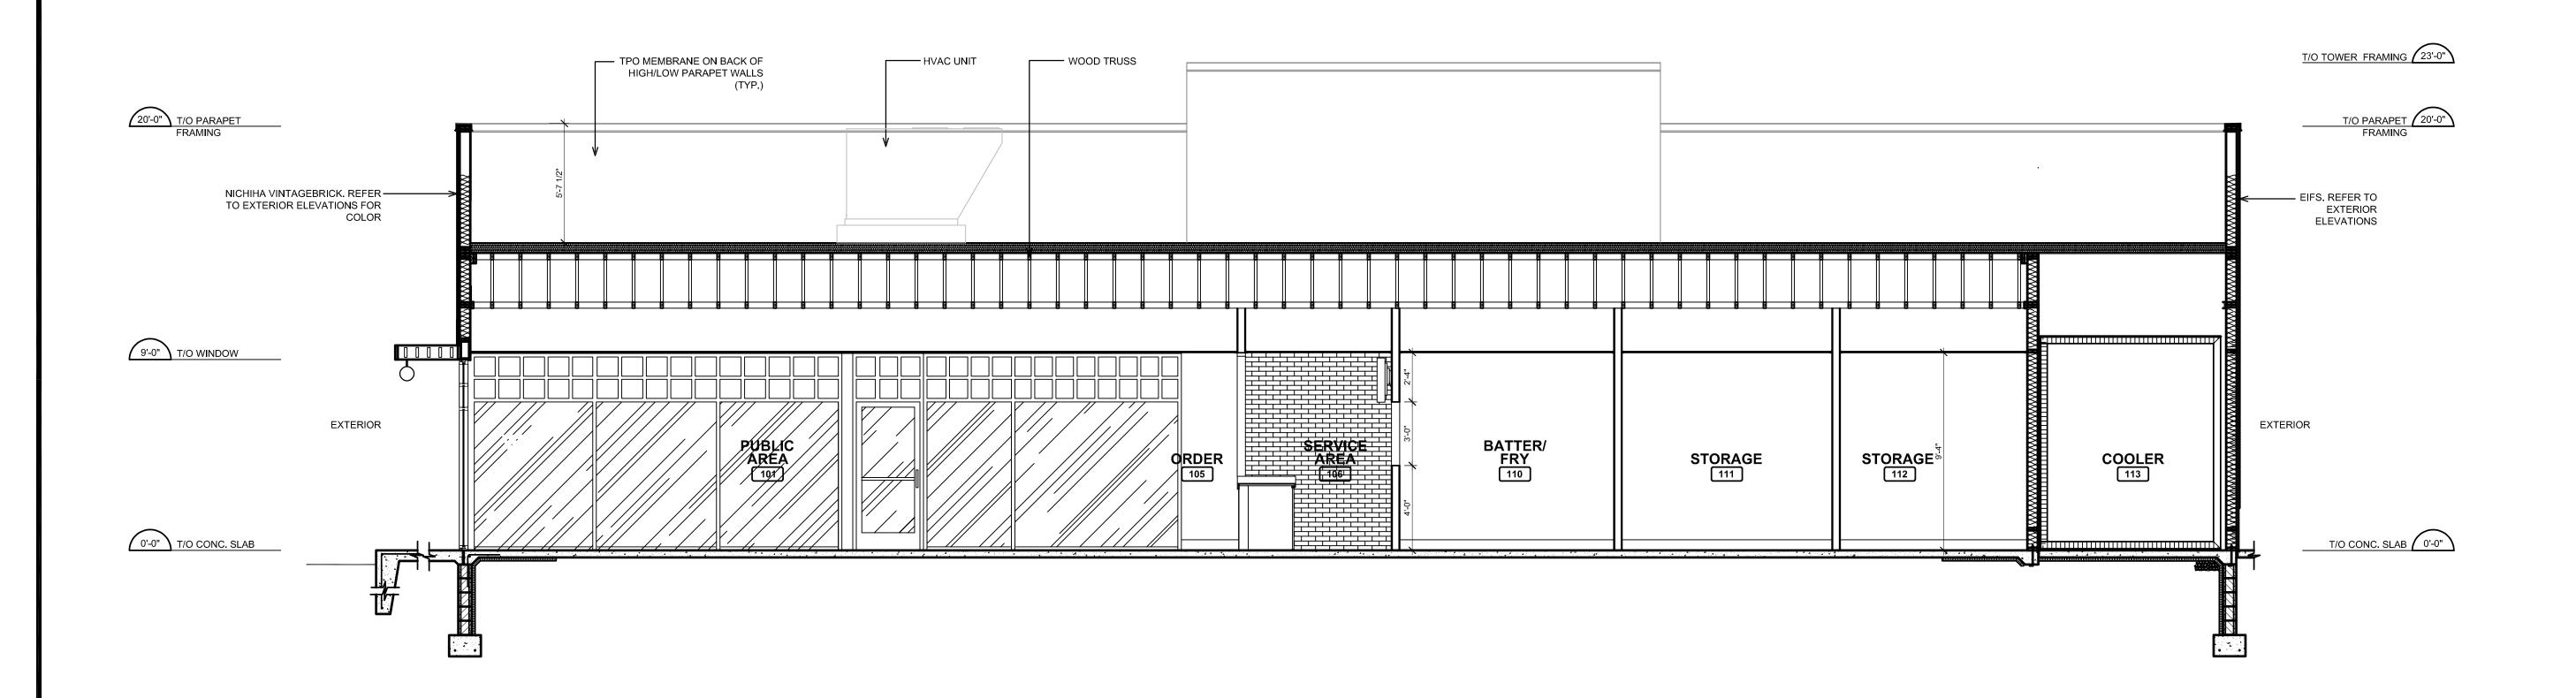PROPOSED BUILDING SECTION A6

$\wedge$		ML
	DESIGN	STUDIO

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ASSESSORS #: 016-150-106-9 ZONING: BBSP LOT SIZE: 3.4 ACRES

POPEYES

**FINISHES** 

TAG	MATERIAL	APPLICATION	SOURCE	PRODUCT	COLOR	DIMENSION	VENDOR
EXTERIOR EF-1	Exterior Wood Siding	Front Facade Exterior Walls	Nichiha Fiber Cement	Vintage Wood AWP 3030	Cedar	17-7/8" H x 119-5/16" L	Matt Stephenson (o)770789.8228
BRICK							popeyes@nichiha.com
EB-1 EB-1	Brick (Clip System)	Front of Building	Nichiha Fiber Cement	Vintage Brick	White Wash Painted EP-1	7 3/8" x 2 1/2" x 3/4"	Matt Stephenson (o)770789.8228 popeyes@nichiha.com
EB-1	Face Brick	Front of Building	Glen-Gery	Aspen White Wirecut	White W804. Use White Mortar	3-5/8 T x 2-1/4 H x 7-5/8 L	popeyes@mcmna.com
EB-2 EB-2	Brick (Clip System)	Accent Tower Brick	Nichiha Fiber Cement	Vintage Brick	Alexandria Buff	7 3/8" x 2 1/2" x 3/4"	Matt Stephenson (o)770789.8228
EB-2	Thin Brick	Accent Tower Brick	Creative Materials Corporation	Thin Brick	Flagstaff	8-1/8" x 2-1/16" x 5/8"	popeyes@nichiha.com Creative Materials Corporation (o) 1-800-207-2967 Ext. 7797 Popeyestile@creativematerialscorp.com
EB-2	Face Brick	Accent Tower Brick	Glen-Gery	Cherry Creek Williamsburg	Red	8-5/8" x 2-13/16" x 3-1/8"	Popeyestile@creativematerialscorp.com
EB-2	Thin Brick	Accent Tower Brick	Design and Direct Source	Sand Urban Series	Flagstaff	2" x 8"	
PAINT EP-1							
EP-1	Exterior Paint	Main Wall Surface, Rear Door	Benjamin Moore	Ultra Spec Ext Low Lustre (N455)	OC-125 Moonlight White		Rodger Lippman (c): 848-702-0239 rodger.lippman@benjaminmoore.com
EP-1	Exterior Paint	Main Wall Surface, Rear Door	Sherwin Williams	A-100 Exterior Latex Satin	SW-7551 Greek Villa		Glenn Remler (c): 954-547-1217 glenn.j.remler@sherwin.com
EP-2 EP-2	Exterior Paint	Brick Tower Parapet	Benjamin Moore	Ultra Spec Ext Low Lustre (N455)	2105-20 Root Beer Candy		Rodger Lippman (c): 848-702-0239
EP-2	Exterior Paint	Brick Tower Parapet	Sherwin Williams	A-100 Exterior Latex Satin	SW-6062 Rugged Brown		rodger.lippman@benjaminmoore.com Glenn Remler (c): 954-547-1217 glenn.j.remler@sherwin.com
EP-3 EP-3	Exterior Paint	Dumpster Walls	Benjamin Moore	Ultra Spec Ext Low Lustre (N455)	HC-170 Stonington Grey		Rodger Lippman (c): 848-702-0239 rodger.lippman@benjaminmoore.com
EP-3	Exterior Paint	Dumpster Walls	Sherwin Williams	A-100 Exterior Latex Satin	SW-7657 Tinsmith		Glenn Remler (c): 954-547-1217 glenn.j.remler@sherwin.com
EP-4 EP-4	Metal Paint	Bollards	Benjamin Moore	Corotech High Solids Rapid	Safety Yellow		Rodger Lippman
EP-4	Metal Paint	Bollards	Sherwin Williams	Dry Enamel Industrial Enamel HS	Safety Yellow		(c): 848-702-0239 rodger.lippman@benjaminmoore.com Glenn Remler
							(c): 954-547-1217 glenn.j.remler@sherwin.com
EP-5	Natal Dalut		Daniania Maara	Occada ab I liab Ociida Danid	Fastan, Fiziala Blasta		
EP-5 EP-5	Metal Paint  Metal Paint	Dumpster Gates and Pylon Pole  Dumpster Gates and Pylon	Benjamin Moore Sherwin Williams	Corotech High Solids Rapid Dry Enamel Industrial Enamel HS	SW-6991 Black Magic		Rodger Lippman (c): 848-702-0239 rodger.lippman@benjaminmoore.com Glenn Remler
EP-6	Wold Fall	Pole	Ondiwin Williams	Industrial Enamer no	CVV 0001 Black Magic		(c): 954-547-1217 glenn.j.remler@sherwin.com
EP-6	Anti Graffitti Coat	Exterior Walls	Benjamin Moore	Aliphatic Acrylic Urethane - Gloss	V500-00 Clear		Rodger Lippman (c): 848-702-0239
EP-6	Anti Graffitti Coat	Exterior Walls	Sherwin Williams	2K Water Based Urethane - Gloss	B65-190/B65V190		rodger.lippman@benjaminmoore.com Glenn Remler (c): 954-547-1217 glenn.j.remler@sherwin.com
MISC							
C-1	Canopy - Metal	Drive Thru Window Canopy	Provided by Manufacturer	Provided by Manufacturer	Orange. Pantone #3564 C		Provided by Manufacturer
C-2 S-1	Canopy - Metal Shutters - Poppy	Building Canopies Exterior Walls Rear of Building	Provided by Manufacturer Provided by Manufacturer	Provided by Manufacturer Provided by Manufacturer	Teal. Pantone #326 C Provided by Manufacturer		Provided by Manufacturer Provided by Manufacturer
DP-1	Door	Main Entrance Doors	Provided by Manufacturer	Provided by Manufacturer	Orange. Pantone #3564 C		Provided by Manufacturer
BRICK							
BR-1 BR-1	Brick (Clip System)	Dining Room Accent Walls	Nichiha Fiber Cement	Vintage Brick	White Wash Painted P-1	7 3/8" x 2 1/2" x 3/4"	Matt Stephenson
BR-1	Thin Brick	Dining Room Accent Walls	Creative Materials	Thin Brick	814 Vintage Brick Painted P-1	7-5/8" x 2-1/4"	(o)770789.8229 popeyes@nichiha.com Creative Materials Corporation
			Corporation				(o) 1-800-207-2967 Ext. 7797 Popeyestile@creativematerialscorp.com
PAINT PT 2							
PT-2 PT-2	Metal Paint	Main Entrance Doors - Interior Frame	Benjamin Moore	Corotech High Solids Rapid Dry Enamel	2133-20 Black Jack		Rodger Lippman (c): 848-702-0239 rodger.lippman@benjaminmoore.com
PT-2	Metal Paint	Main Entrance Doors - Interior Frame	Sherwin Williams	Industrial Enamel HS	SW-6991 Black Magic		rodger.lippman@benjaminmoore.com Glenn Remler (c): 954-547-1217 glenn.j.remler@sherwin.com

# CITY OF BRENTWOOD

GRADING AND DRAINAGE PLAN FOR:

# PROPOSED POPEYE'S RESTUARANT

APN: 016-150-106-9

- THE WORK EMBRACED HEREIN SHALL BE DONE IN ACCORDANCE WITH THE APPROPRIATE PROVISION OF THE SPECIFICATIONS ENTITLED BY CITY OF BRENTWOOD, STANDARD PLANS AND SPECIFICATIONS LATEST REVISION.
- THE CONTRACTOR SHALL SECURE AN ENCROACHMENT PERMIT FOR ANY OFF-SITE CONSTRUCTION.
- ALL PERMITS INCLUDING ENCROACHMENT AND BARRICADE PLANS SHALL BE KEPT ON-SITE AT ALL TIMES.
- ANY PERSON, CONTRACTOR OR SUBCONTRACTOR PLANNING TO CONDUCT ANY EXCAVATION SHALL CONTACT USA NORTH AT 811 AT LEAST TWO (2) DAYS, BUT NOT MORE THAN 14 CALENDAR DAYS, PRIOR TO COMMENCING THAT EXCAVATION PRIOR TO ACCEPTANCE, BOND RELEASES AND A CERTIFICATE OF OCCUPANCY, A CERTIFIED LEGIBLE AS-BUILT DRAWING MUST
- CERTIFIED AS SUCH BY THE DEVELOPER'S ENGINEER. ALL CONSTRUCTION EQUIPMENT SHALL BE TUNED AND MAINTAINED IN ACCORDANCE WITH THE MANUFACTURER'S

BE SUBMITTED TO THE CITY OF BRENTWOOD. AS-BUILT MUST SHOW ALL CHANGES AND ACTUAL FIELD CONDITIONS. IN THE

- CONTRACTOR'S WORK CREWS SHALL SHUT OFF CONSTRUCTION EQUIPMENT WHEN NOT IN USE ALL UTILITY POLES IN THE STREET RIGHT-OF-WAY ARE TO BE REMOVED OR RELOCATED PRIOR TO ANY PAVING.
- ANY SEPTIC TANK, LEACH FIELD OR RELATED FACILITIES LOCATED IN AREAS TO BE GRADED, UNLESS OTHERWISE DIRECTED BY THE PLANS, SHALL BE ABANDONED PER COUNTY OF CONTRA COSTA HEATH DEPARTMENT STANDARDS. A BUILDING PERMIT WILL BE REQUIRED FOR THIS WORK AND FEES THEREFORE SHALL BE PAID FOR BY THE CONTRACTOR.
- (REGULATION VIII) CONCERNING DUST SUPPRESSION DURING CONSTRUCTION OF THE PROJECT. METHODS INCLUDE, BUT ARE NOT LIMITED TO: USE OF WATER OR CHEMICAL STABILIZERS/SUPPRESSANTS TO CONTROL DUST EMISSIONS FROM DISTURBED AREA. STOCK PILES. AND ACCESS WAYS: COVERING OR WETTING MATERIALS THAT ARE TRANSPORTED OFF-SITE: LIMIT CONSTRUCTION RELATED SPEEDS TO 15 MPH ON ALL UNPAVED AREAS, USE OF A STABILIZED CONSTRUCTION ENTRY/EXIT (E.G. 3-6 INCH AGGREGATE OR GRATES) TO MINIMIZE CARRYOUT/TRACKOUT FROM CONSTRUCTION VEHICLES ENTERING PUBLIC STREETS; AND CEASE GRADING AND EARTH MOVING DURING PERIODS OF HIGH WINDS (20MPH OR MORE).


- ANY EXISTING SECTION CORNER, QUARTER SECTION CORNER, PROPERTY CORNER, STREET CENTERLINE MONUMENT, OR ANY PLANS, SHALL BE RESET TO THE SATISFACTION OF THE CITY ENGINEER. A LICENSED LAND SURVEYOR OR CIVIL ENGINEER LICENSED TO PERFORM LAND SURVEYING SHALL CERTIFY THE PLACEMENT OR REPLACEMENT OF ALL MONUMENTS AND BENCHMARKS IN ACCORDANCE WITH ALL LAWS, RULES AND REGULATIONS GOVERNING SUCH PLACEMENTS OR REPLACEMENTS. PLACEMENT/REPLACEMENT AND CERTIFICATION SHALL BE COMPLETED BEFORE FINAL ACCEPTANCE OF THE BE FURNISHED BY THE CONTRACTOR.
- AMAGED, DISTURBED OR FADED BY CONSTRUCTION ACTIVITIES SHALL BE REPLACED IN-KIND IN ACCORDANCE WITH THE CITY OF FRESNO STANDARDS AND AS DIRECTED BY THE CITY ENGINEER.
- CONSTRUCTION CONTRACTOR AGREES THAT IN ACCORDANCE WITH GENERALLY ACCEPTED CONSTRUCTION PRACTICES, CONSTRUCTION CONTRACTOR WILL BE REQUIRED TO ASSUME SOLE AND COMPLETE RESPONSIBILITY FOR JOB SITE CONDITIONS DURING THE COURSE OF CONSTRUCTION OF THE PROJECT, INCLUDING SAFETY OF ALL PERSONS AND PROPERTY. THIS REQUIREMENT SHALL BE MADE TO APPLY CONTINUOUSLY AND NOT BE LIMITED TO NORMAL WORKING HOURS.


- ALL SITE GRADING SHALL COMPLY WITH CALIFORNIA BUILDING CODE, 2022 EDITION. THE GRADING CONTRACTOR SHALL REMOVE ALL ORGANIC MATTER, DEBRIS, AND OTHER DELETERIOUS MATERIAL FROM THE
- 3. SUBGRADE TO BE COMPACTED TO 95% RELATIVE COMPACTION BASED ON ASTM D-1557-78. PROVIDE COMPACTION REPORTS
- PREPARED BY AN APPROVED TESTING AGENCY. A LETTER FROM THE RESPONSIBLE CIVIL ENGINEER OR LAND SURVEYOR SHALL ALSO BE SUBMITTED CERTIFYING THAT GRADING CONFORMED TO THE APPROVED GRADING PLAN.
- THIS GRADING PLAN IS FOR APPROVAL OF ONSITE ELEVATIONS ONLY. THE ELEVATIONS SHOWN WITH IN THE PUBLIC RIGHT-OF-WAY REQUIRES SEPARATE PUBLIC WORKS DEPARTMENT APPROVAL & PERMIT. ANY NOTES THAT APPLY TO THI PUBLIC RIGHT-OF-WAY ARE FOR REFERENCE ONLY. IF ON-SITE ELEVATIONS SHOWN DO NOT COINCIDE WITH APPROVED
- STREET PLANS, AN APPROVED AMENDMENT IS REQUIRED. THE GROUND IMMEDIATELY ADJACENT TO ALL FOUNDATIONS SHALL BE SLOPED AWAY FROM THE BUILDING AT A SLOPE OF NOT LESS THAN 5% FOR A MINIMUM DISTANCE OF 10 FEET MEASURED PERPENDICULAR TO THE FACE OF THE WALL. IF PHYSICAL OBSTRUCTIONS OR LOT LINES PROHIBIT 10 FEET OF HORIZONTAL DISTANCE FROM THE FOUNDATION, THEN A SWALE THAT RUNS PARALLEL TO THE FOUNDATION MAY BE USED AND WILL BE REQUIRED TO BE A MINIMUM SLOPE OF 5% WITHIN 10 FEET OF THE BUILDING FOUNDATION. ALL OTHER SITE GRADING OUTSIDE OF THE BUILDING ENVELOPE IS REQUIRED TO BE A
- NO SURFACE DRAINAGE SHALL BE PERMITTED TO DRAIN ONTO ADJACENT PROPERTIES.
- NO PERMANENT ON-SITE WATER RETENTION IS ALLOWED.
- ANY VERTICAL CUT OR FILL DIFFERENTIAL EQUAL TO OR GREATER THAN TWELVE (12) INCHES BETWEEN ADJACENT PROPERTIES SHALL BE SUPPORTED BY AN APPROVED RETAINING WALL
- 10. ALL REQUIRED WALLS AND RETAINING WALLS REQUIRE SEPARATE BUILDING PERMITS IN ADDITION TO THE GRADING PERMIT. ALL REQUIRED RETAINING WALL AND BLOCK WALLS WILL NEED TO BE FINALED BEFORE AS-GRADE CAN BE APPROVED.
- 12. PROVIDE THE CITY OF FRESNO WITH AS-GRADE PLANS. PLANS ARE TO BE SUBMITTED UPON COMPLETION OF GRADING AND
- 13. UPON COMPLETION OF THE GRADING THE SOIL ENGINEER IS TO PROVIDE "FINAL SOIL REPORT"; INDICATING ALL EARTHWORK WAS COMPLETED AS REQUIRED IN THE PRELIMINARY REPORT.

# **BENCHMARK**

2" BRASS CAP, FOUND FLUSH ON TOP OF HEADWALL, AT THE NORTHWEST END OF THE HEADWALL. HEADWALL IS LOCATED 200' WESTERLY OF THE CENTER OF THE INTERSECTION OF BRENTWOOD BLVD AND SELLERS AVENUE, WEST OF THE RAIL ROAD TRACK, APPROX. 270'± NORTH OF PAYNE AVENUE.

ELEV: 65.8' NAVD 88

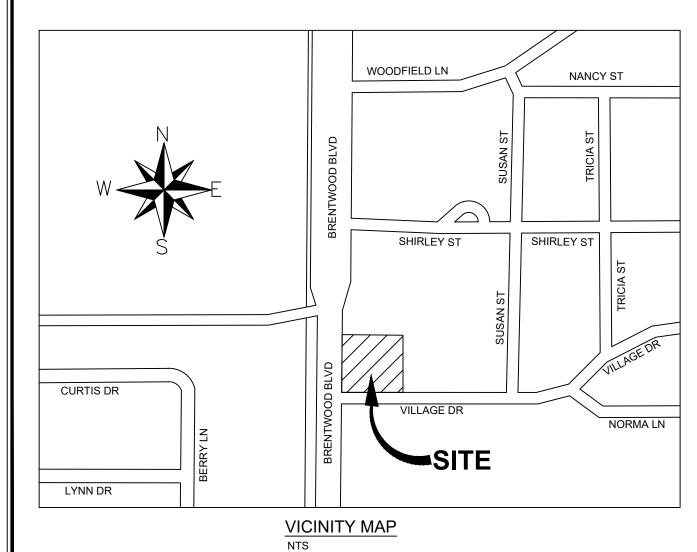

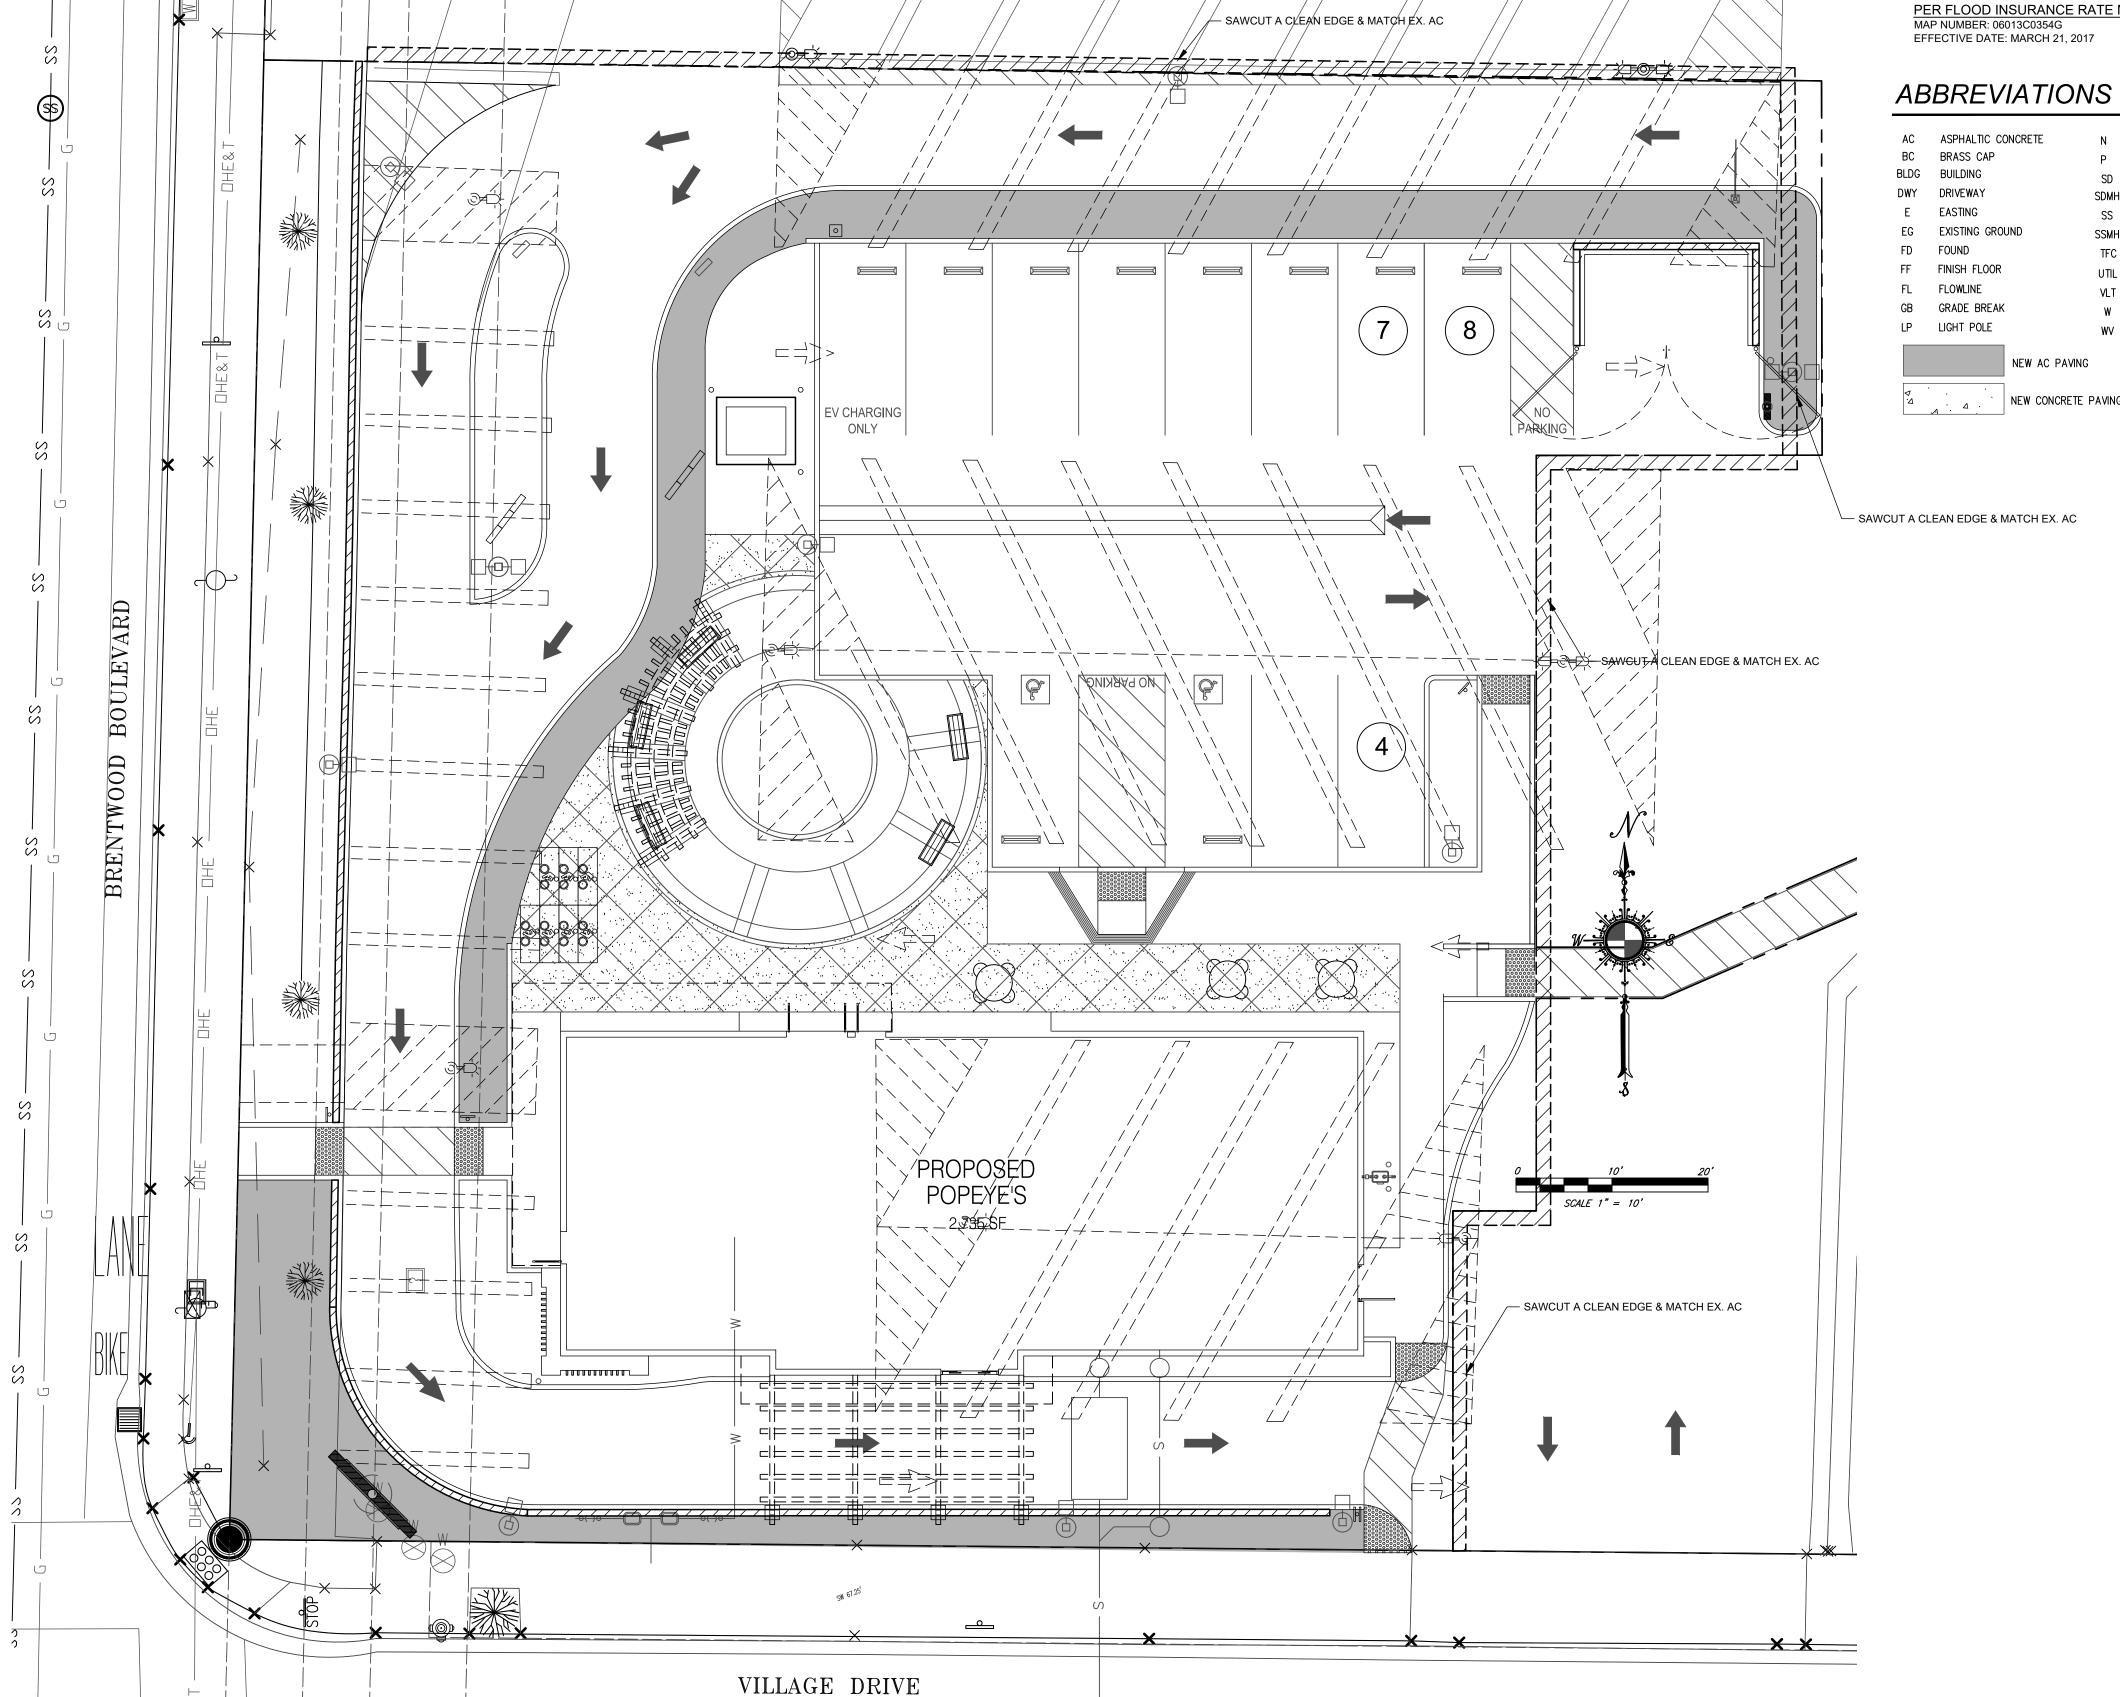

# DESCRIPTION

**COVER SHEET GRADING PLAN** UTILITY PLAN

**EROSION CONTROL PLAN** 

## OWNER INFO

SUNNY GHAI GHAI MANAGEMENT SERVICES, INC. 25 E. AIRWAY BLVD. LIVERMORE, CA 94551 SUNNY@GHAIMANANGEMENT.COM

## FLOOD DESIGNATION

# AREAS DETERMINED TO BE OUTSIDE THE 0.2% ANNUAL CHANCE FLOOD

PER FLOOD INSURANCE RATE MAP

PAVEMENT SD STORM DRAIN SSMH SANITARY SEWER MANHOLE TFC TOP FACE CURB

W WATER WV WATER VALVE

DRAWN BY:

PROJ. ENGR:


PREPARED FOR GHAI MANAGEMENT


PROJECT#

ME-321

SERVICES, INC. 25 E. AIRWAY BLVD LIVERMORE, CA 94551

SHEET NO.

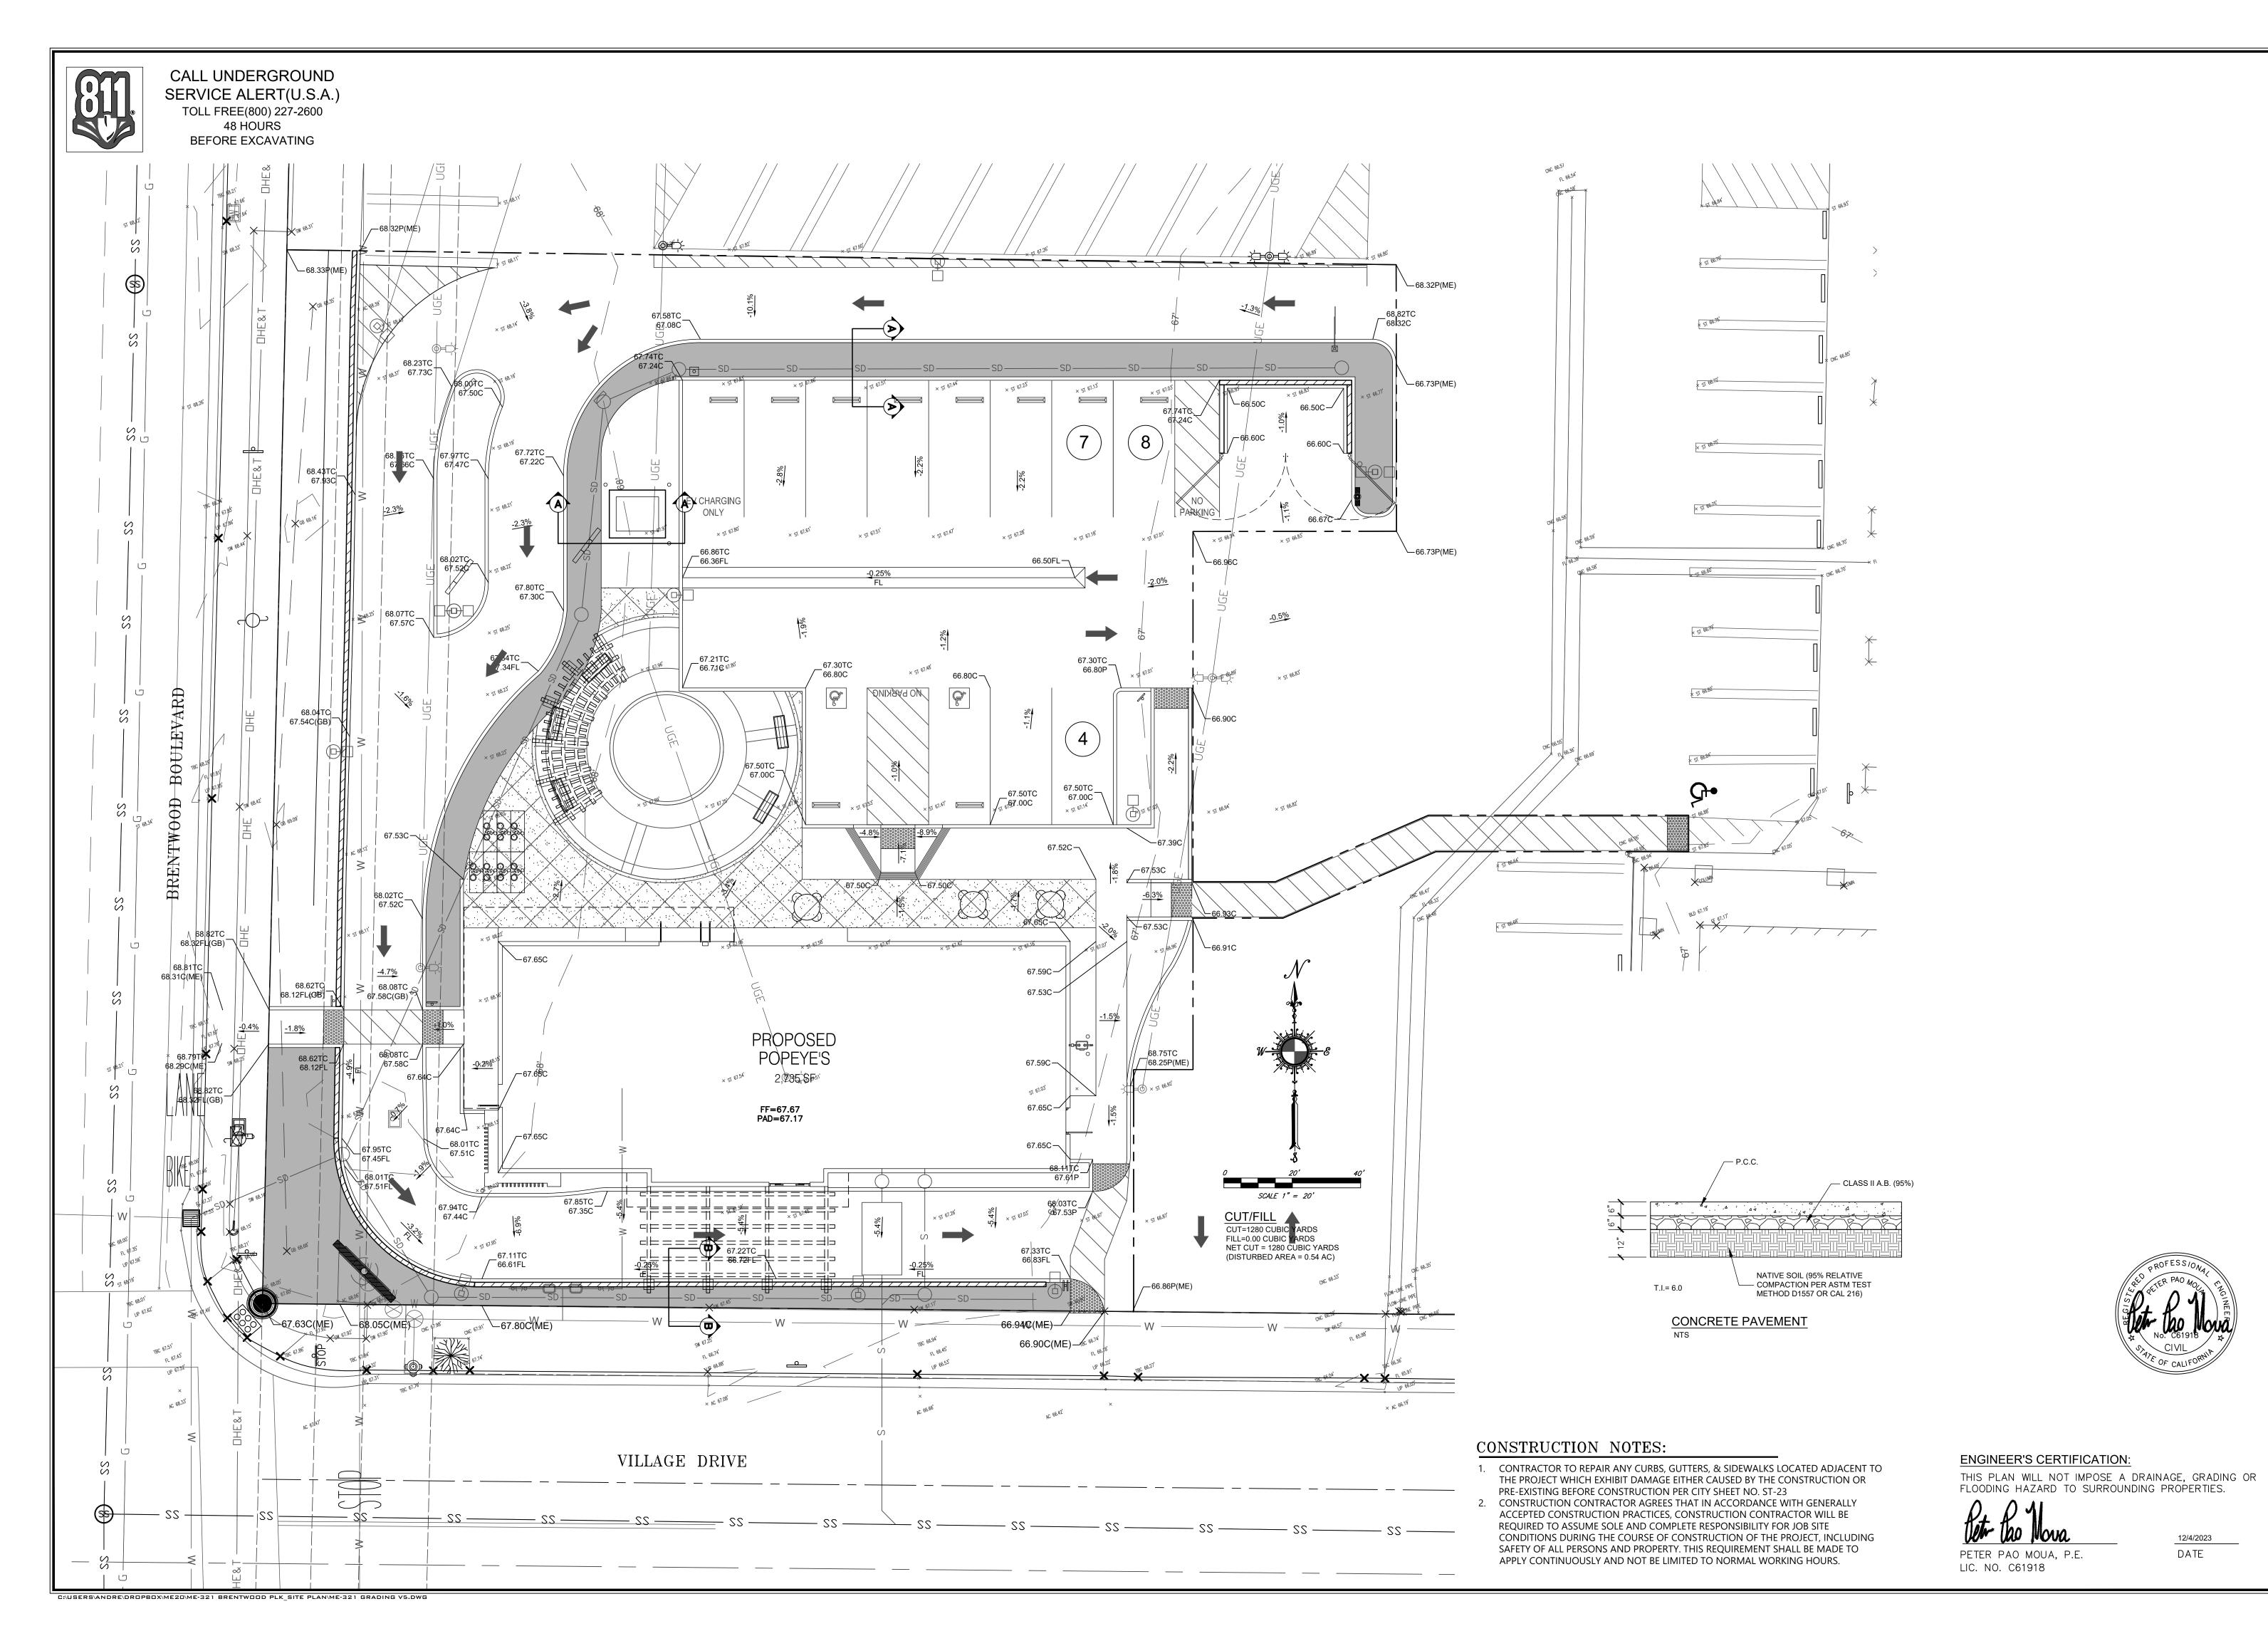

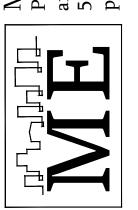

GED BRE PN

DRAWN BY: PPM

PROJ. ENGR: PPM

PROJECT#

ME-321


PREPARED FOR:

SUNNY GHAI GHAI MANAGEMENT SERVICES, INC. 25 E. AIRWAY BLVD LIVERMORE, CA 94551

SHEET NO.

12/4/2023

DATE

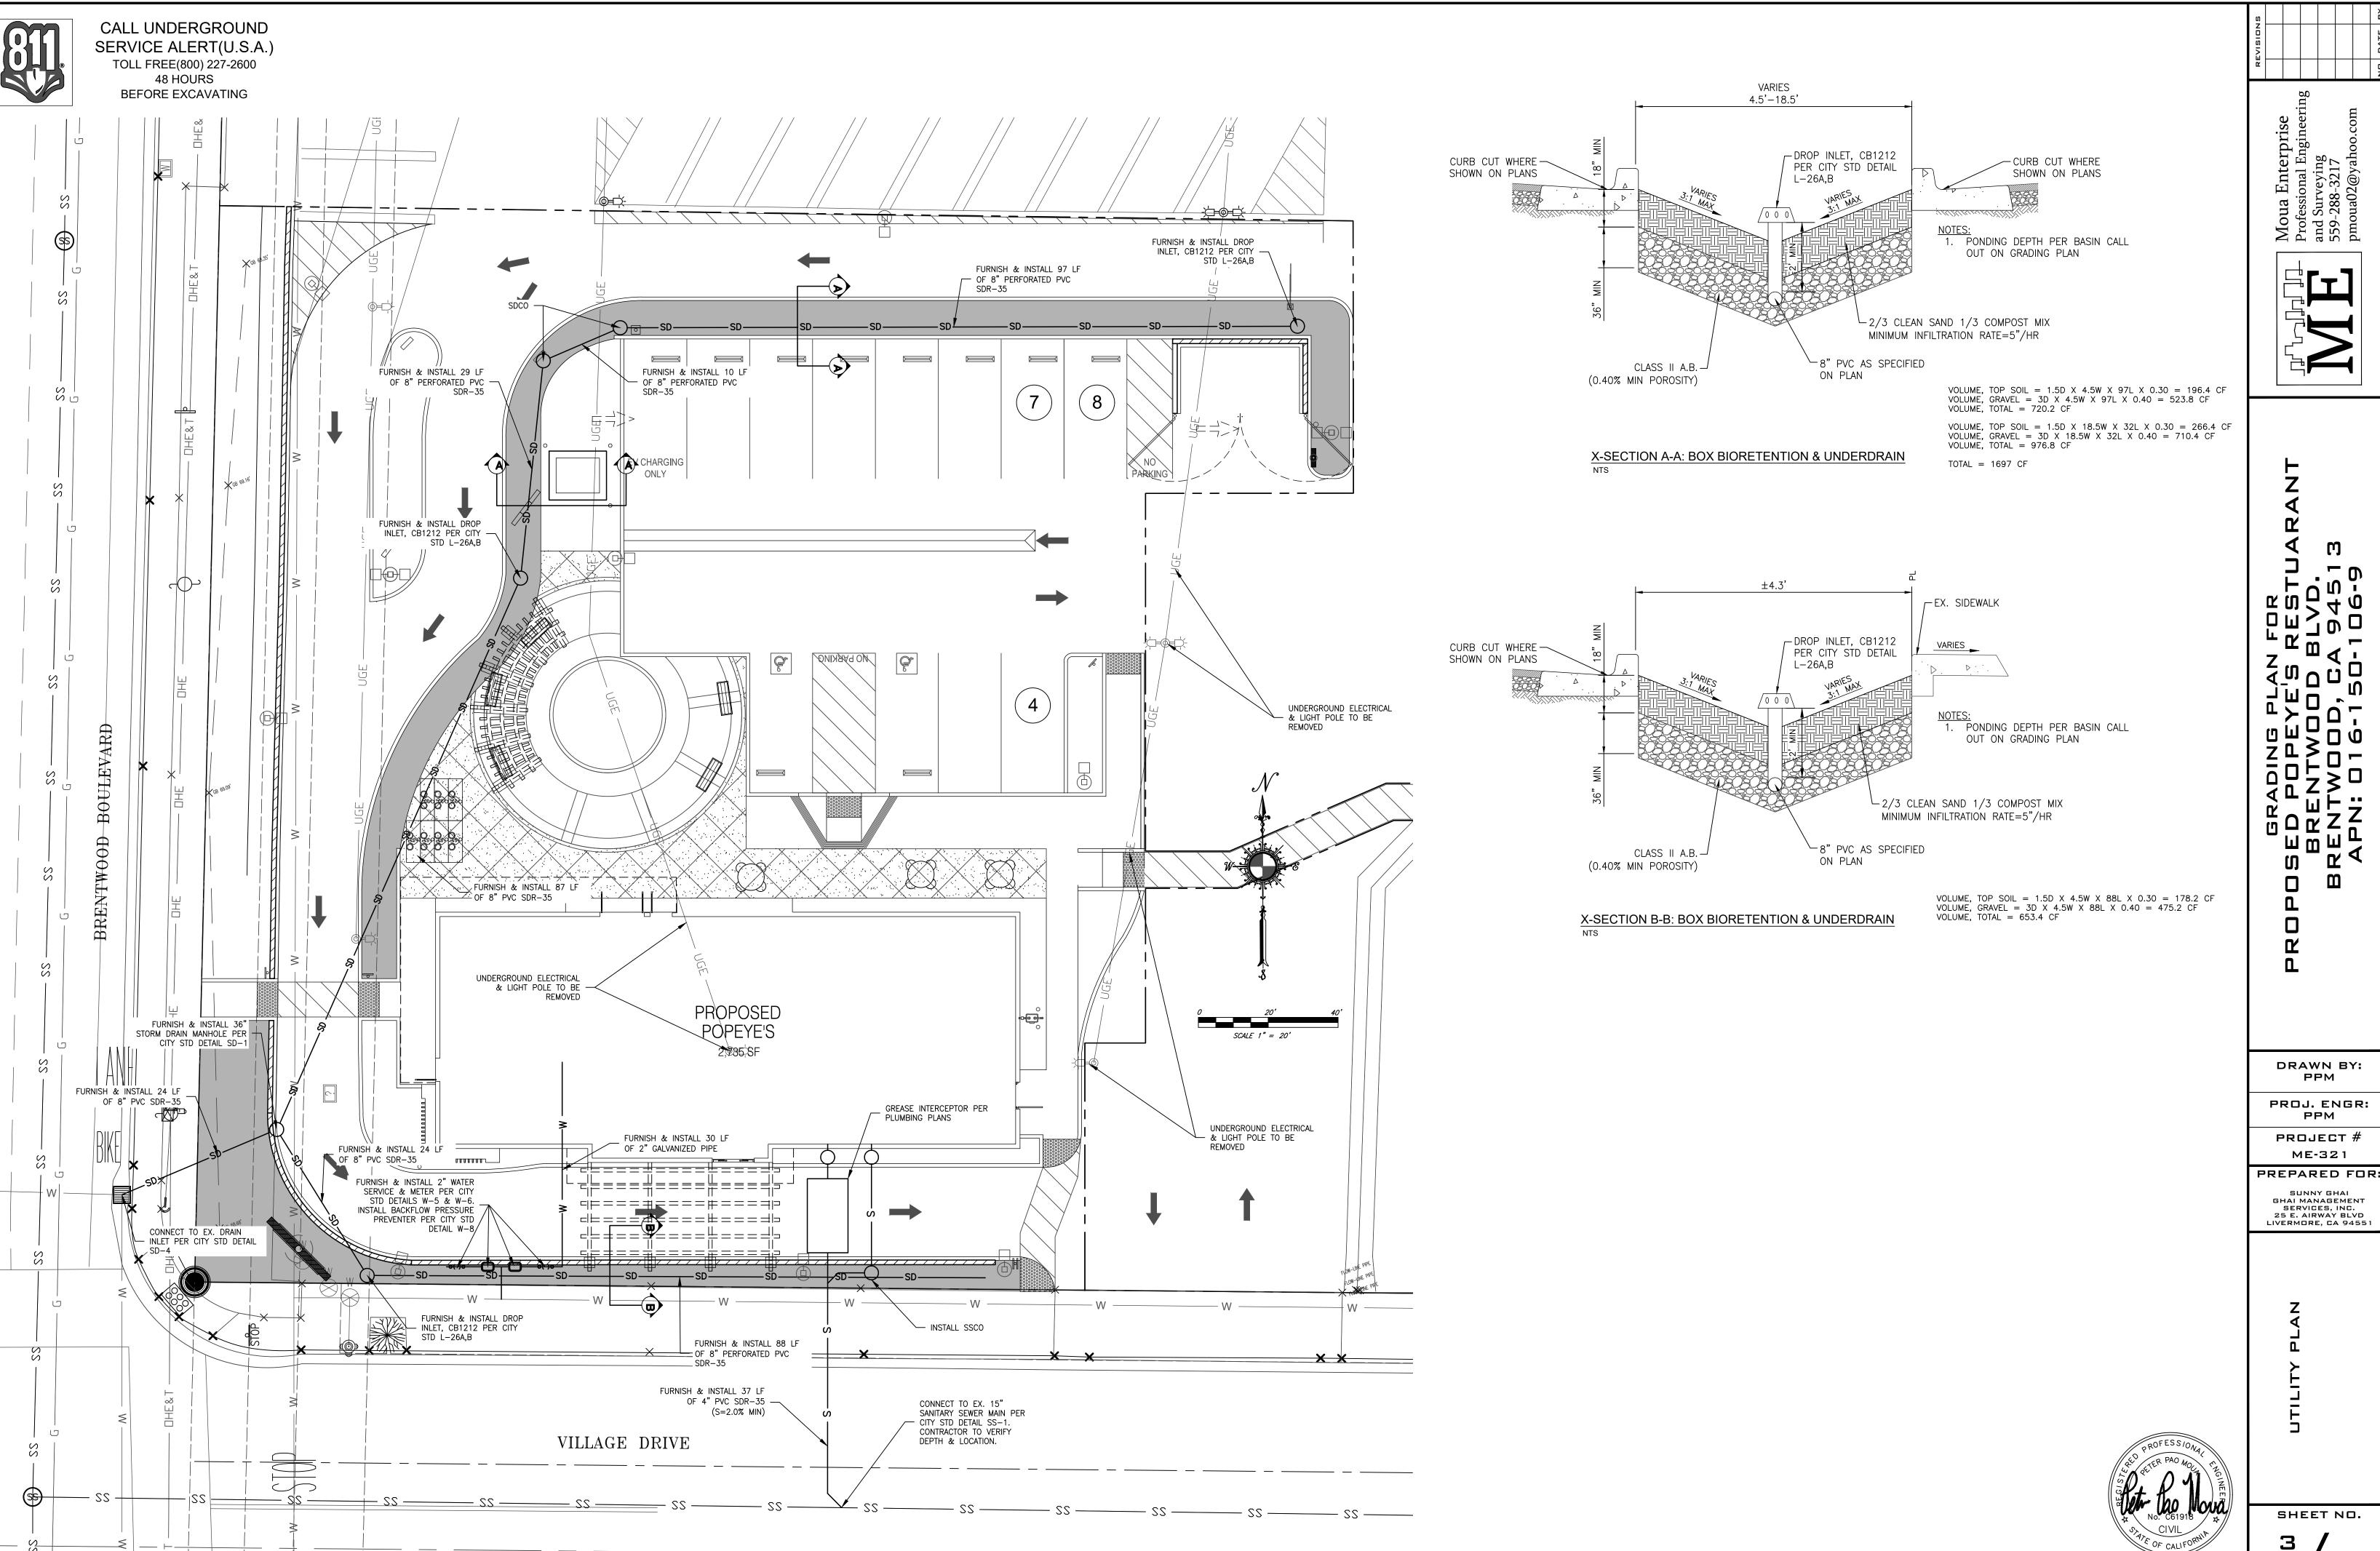

C:\USERS\ANDRE\DROPBOX\ME20\ME-321 BRENTWOOD PLK\_SITE PLAN\ME-321 GRADING V5.DWG

GRAC BED P BREN SENTW APN: (  $\Box$ 


> DRAWN BY: PPM

PROJ. ENGR: PPM

PROJECT# ME-321

SUNNY GHAI GHAI MANAGEMENT SERVICES, INC. 25 E. AIRWAY BLVD LIVERMORE, CA 94551

SHEET NO.

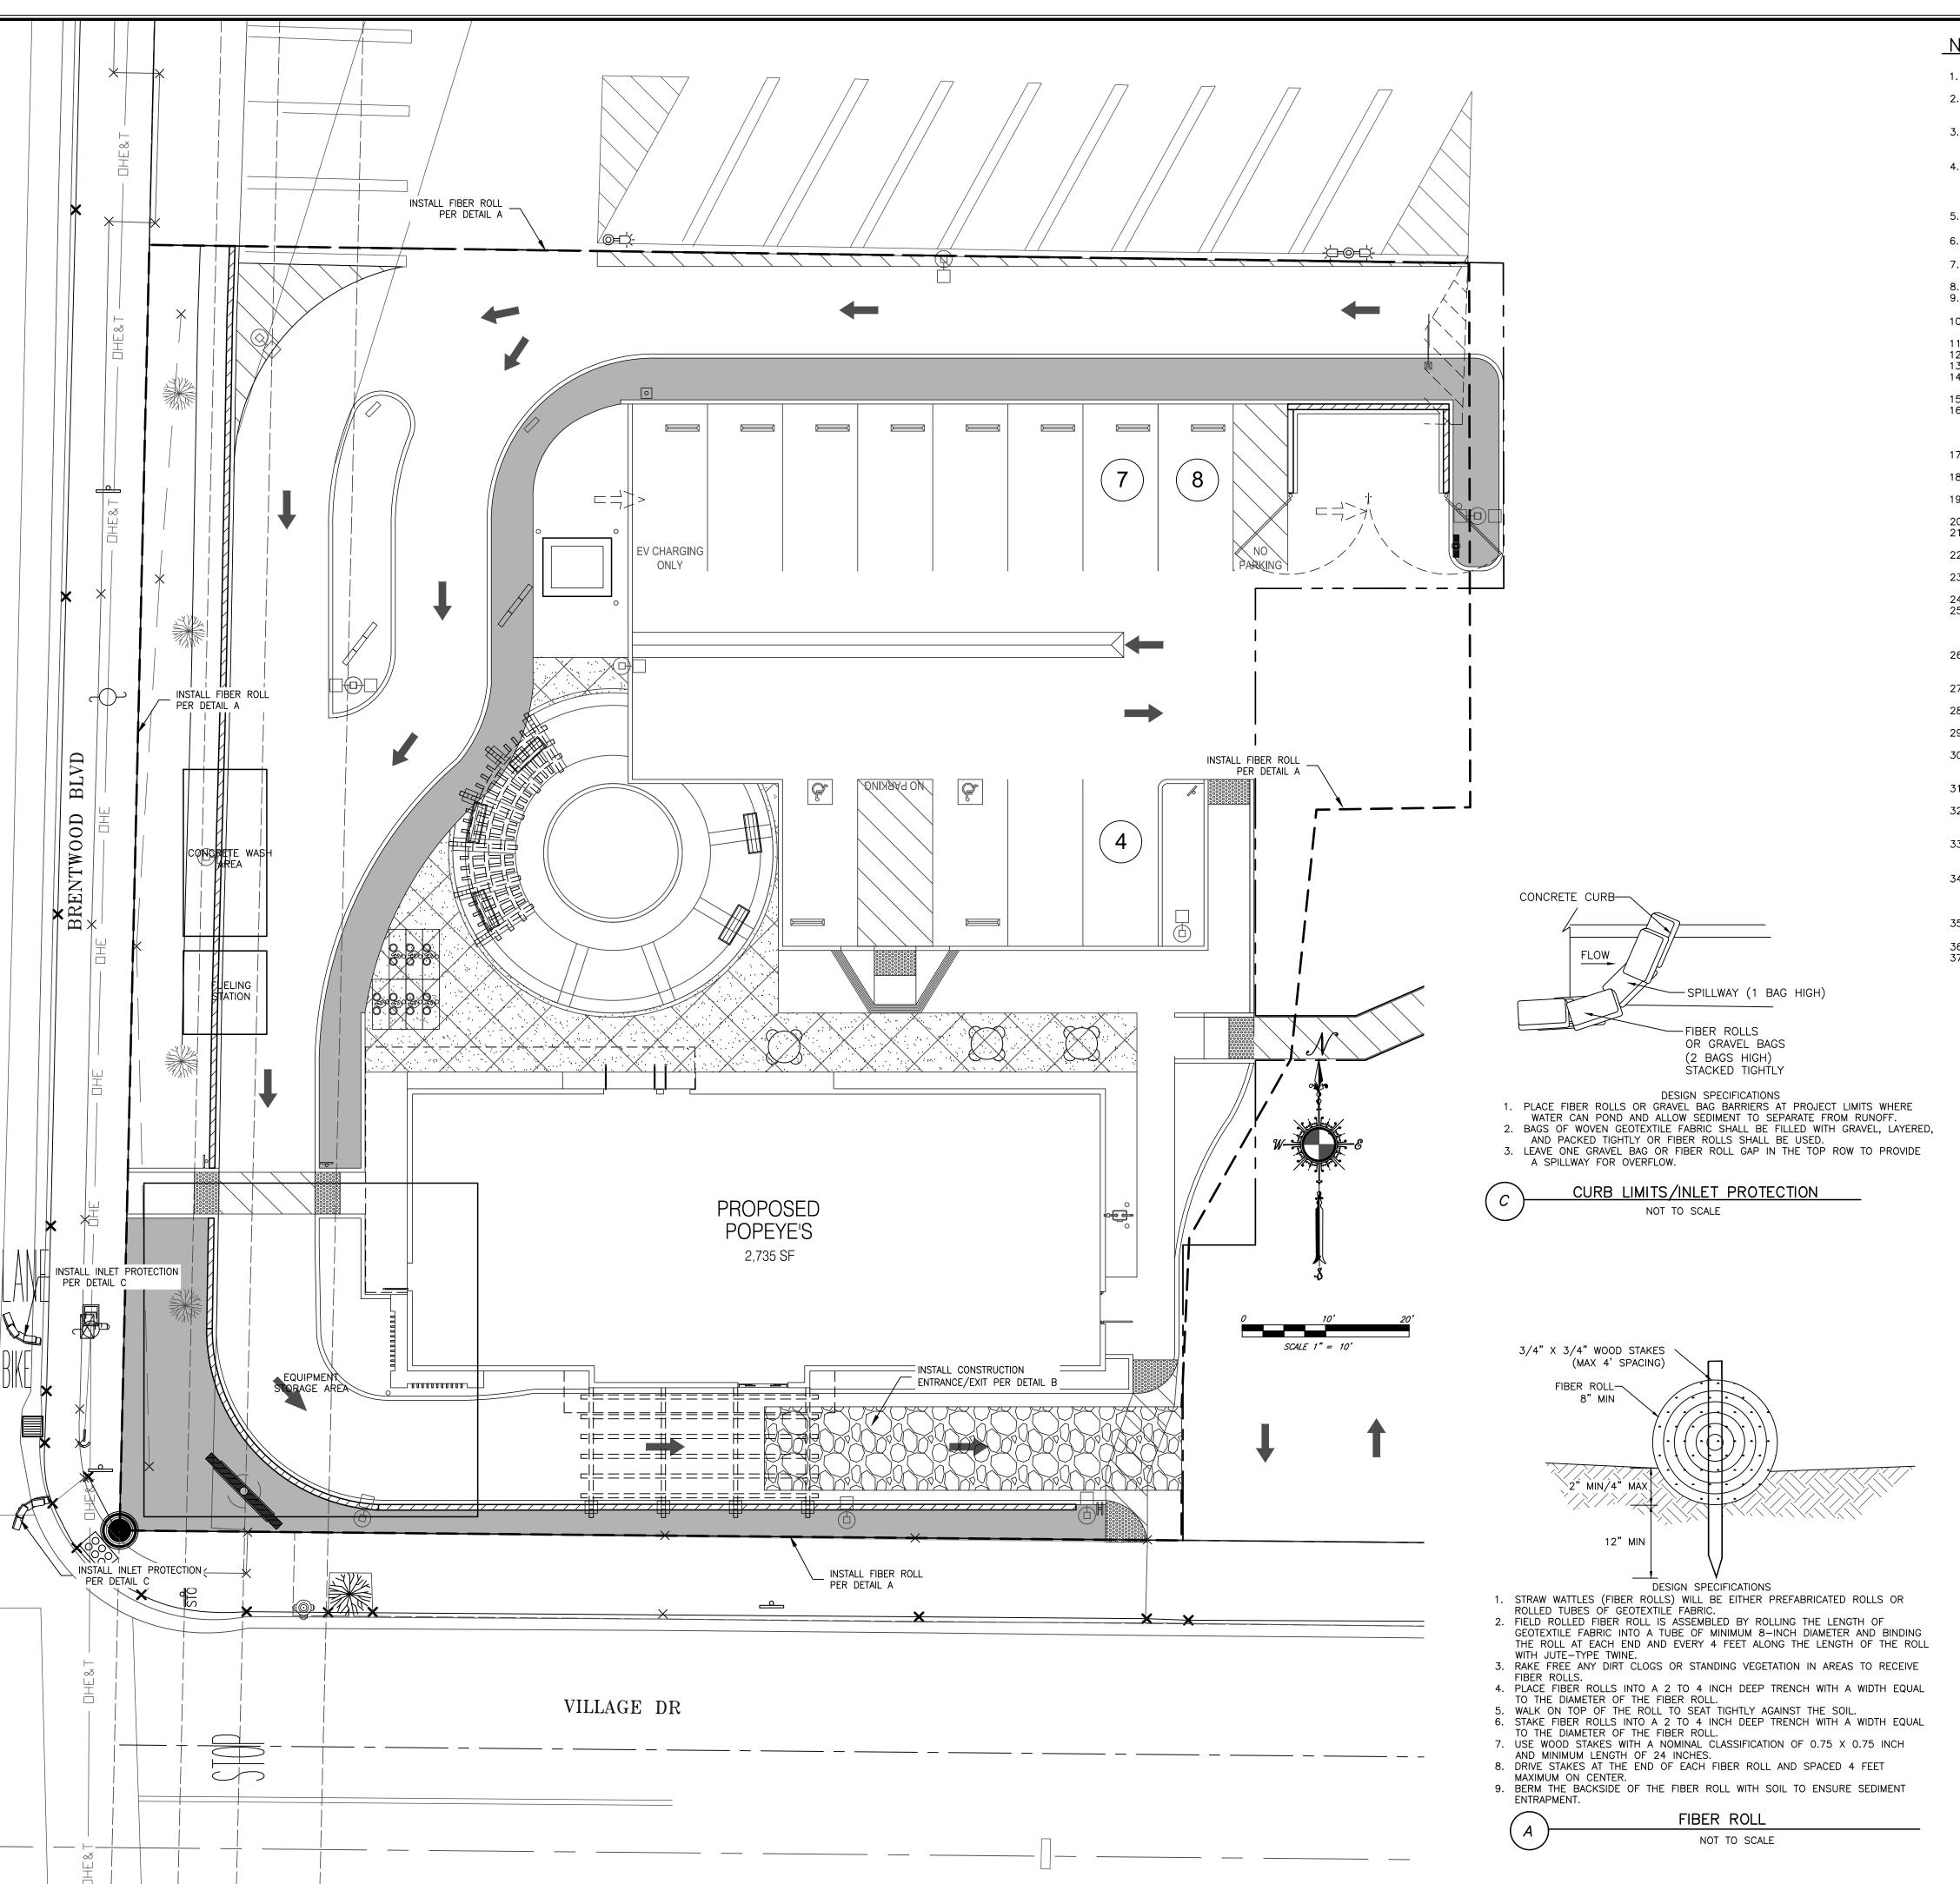

:\USERS\ANDRE\DROPBOX\ME20\ME-321 BRENTWOOD PLK SITE PLAN\ME-321 GRADING V5.DWG

# NOTES:

APPROPRIATE BMPs.

- 1. IT IS THE CONTRACTORS RESPONSIBILITY TO VERIFY THAT ALL BMP'S NECESSARY ARE IMPLEMENTED INCLUDING, BUT NOT LIMITED TO THE METHODS SHOWN ON THE EROSION CONTROL PLAN.
- 2. STORM WATER DISCHARGES AND AUTHORIZED NON-STORM WATER DISCHARGES SHALL NOT CONTAIN A HAZARDOUS SUBSTANCE EQUAL TO OR IN EXCESS OF REPORTABLE QUANTITIES ESTABLISHED IN 40 C.F.R. 117.3 AND 302.4, UNLESS A SEPARATE NPDES PERMIT HAS BEEN ISSUED TO REGULATE THOSE DISCHARGES.
- 3. MINIMIZE OR PREVENT POLLUTANTS IN STORM WATER DISCHARGES AND AUTHORIZED NON-STORM WATER DISCHARGES THROUGH THE USE OF CONTROLS, STRUCTURES, AND MANAGEMENT PRACTICES THAT ACHIEVE BAT FOR TOXIC AND NON-CONVENTIONAL POLLUTANTS AND BCT FOR CONVENTIONAL POLLUTANTS.
- 4. CONDUCT AN INVENTORY OF THE PRODUCTS USED AND/OR EXPECTED TO BE USED AND THE END PRODUCTS THAT ARE PRODUCED AND/OR EXPECTED TO BE PRODUCED. THIS DOES NOT INCLUDE MATERIALS AND EQUIPMENT THAT ARE DESIGNED TO BE OUTDOORS AND EXPOSED TO ENVIRONMENTAL CONDITIONS (i.e. POLES, EQUIPMENT PADS, CABINETS, CONDUCTORS, INSULATORS, BRICKS, ETC.)
- INSULATORS, BRICKS, ETC.)
  5. COVER AND BERM LOOSE STOCKPILED CONSTRUCTION MATERIALS THAT ARE NOT ACTIVELY BEING USED (i.e. SOIL, SPOILS, AGGREGATE, FLY—ASH, STUCCO, HYDRATED LIME, ETC.)
- 6. STORE CHEMICALS IN WATERTIGHT CONTAINERS (WITH APPROPRIATE SECONDARY CONTAINMENT TO PREVENT ANY SPILLAGE OR LEAKAGE) IN A STORAGE SHED (COMPLETELY ENCLOSED.)
  7. MINIMIZE EXPOSURE OF CONSTRUCTION MATERIALS TO PRECIPITATION. THIS DOES NO INCLUDE MATERIALS AND EQUIPMENT THAT
- ARE DESIGNED TO BE OUTDOORS AND EXPOSED TO ENVIRONMENTAL CONDITIONS.

  8. IMPLEMENT BMPs TO PREVENT THE OFF—SITE TRACKING OF LOOSE CONSTRUCTION AND LANDSCAPE MATERIALS.

  9. PREVENT DISPOSAL OF ANY RINSE OR WASH WATERS OR MATERIALS ON IMPERVIOUS OR PERVIOUS SITE SURFACES OR INTO THE
- STORM DRAIN SYSTEM.

  10. ENSURE THE CONTAINMENT OF SANITATION FACILITIES (e.g. PORTABLE TOILETS) TO PREVENT DISCHARGES OF POLLUTANTS TO THE STORM WATER DRAINAGE SYSTEM OR RECEIVING WATER.
- 11. CLEAN OR REPLACE SANITATION FACILITIES AND INSPECT THEM REGULARLY FOR LEAKS AND SPILLS.

  12. COVER WASTE DISPOSAL CONTAINERS AT THE END OF EVERY BUSINESS DAY AND DURING A RAIN EVENT.
- 13. PREVENT DISCHARGES FROM WASTE DISPOSAL CONTAINERS TO THE STORM WATER DRAINAGE SYSTEM OR RECEIVING WATER.
  14. CONTAIN AND SECURELY PROTECT STOCKPILED WASTE MATERIAL FROM WIND AND RAIN AT ALL TIMES UNLESS ACTIVELY BEING
- 15. IMPLEMENT PROCEDURES THAT EFFECTIVELY ADDRESS HAZARDOUS AND NON-HAZARDOUS SPILLS.

  16. DEVELOP A SPILL RESPONSE AND IMPLEMENTATION ELEMENT OF THE SWPPP PRIOR TO COMMENCEMENT OF CONSTRUCTION ACTIVITIES. EQUIPMENT AND MATERIALS FOR CLEANUP OF SPILLS SHALL BE AVAILABLE ON SITE AND THAT SPILLS AND LEAKS
- SHALL BE CLEANED UP IMMEDIATELY AND DISPOSED OF PROPERLY. APPROPRIATE SPILL RESPONSE PERSONNEL SHOULD BE ASSIGNED AND TRAINED.

  17. ENSURE THE CONTAINMENT OF CONCRETE WASHOUT AREAS AND OTHER WASHOUT AREAS THAT MAY CONTAIN ADDITIONAL POLLUTANTS SO THERE IS NO DISCHARGE INTO THE UNDERLYING SOIL AND ONTO THE SURROUNDING AREAS.
- 18. PREVENT OIL, GREASE, OR FUEL FROM VEHICLE STORAGE OR MAINTENANCE FROM LEAKING INTO THE GROUND, STORM DRAINS OR SURFACE WATERS.

  19. PLACE ALL EQUIPMENT OR VEHICLES, WHICH ARE TO BE FUELED, MAINTAINED AND STORED IN A DESIGNATED AREA FITTED WITH
- 20. CLEAN LEAKS IMMEDIATELY AND DISPOSE OF LEAKED MATERIALS PROPERLY.
  21. CONTAIN FERTILIZERS AND OTHER STOCKPILED LANDSCAPE MATERIALS SUCH AS MULCHES AND TOPSOIL WHEN THEY ARE NOT ACTIVELY BEING USED.
- ACTIVELY BEING USED.

  22. DISCONTINUE THE APPLICATION OF ANY ERODIBLE LANDSCAPE MATERIAL WITHIN TWO DAYS BEFORE A FORECASTED RAIN EVENT OR DURING PERIODS OF PRECIPITATION.
- DURING PERIODS OF PRECIPITATION.

  23. APPLY ERODIBLE LANDSCAPE MATERIAL AT QUANTITIES AND APPLICATION RATES ACCORDING TO MANUFACTURER RECOMMENDATIONS OR BASED ON WRITTEN SPECIFICATION BY KNOWLEDGEABLE AND EXPERIENCED FIELD PERSONNEL.
- OR BASED ON WRITTEN SPECIFICATION BY KNOWLEDGEABLE AND EXPERIENCED FIELD PERSONNEL.

  24. STACK ERODIBLE LANDSCAPE MATERIAL ON PALLETS AND COVER OR STORE SUCH MATERIALS WHEN NOT BEING USED OR APPLIED.

  25. CONDUCT AN ASSESSMENT AND CREATE A LIST OF POTENTIAL POLLUTANT SOURCES AND IDENTIFY ANY AREAS OF THE SITE WHERE ADDITIONAL BMPs ARE NECESSARY TO REDUCE OR PREVENT POLLUTANTS IN STORM WATER DISCHARGES AND AUTHORIZED
- NON-STORM WATER DISCHARGES. KEEP THIS LIST WITH THE SWPPP AND IDENTIFY ALL NON-VISIBLE POLLUTANTS WHICH ARE KNOWN, OR SHOULD BE KNOWN, TO OCCUR ON THE CONSTRUCTION SITE.


  26. IMPLEMENT GOOD HOUSEKEEPING MEASURES ON THE CONSTRUCTION SITE TO CONTROL THE AIR DEPOSITION OF SITE MATERIALS
- 26. IMPLEMENT GOOD HOUSEKEEPING MEASURES ON THE CONSTRUCTION SITE TO CONTROL THE AIR DEPOSITION OF SITE MATERIALS AND FROM SITE OPERATIONS. SUCH PARTICULATES CAN INCLUDE, BUT ARE NOT LIMITED TO, SEDIMENT, NUTRIENTS, TRASH, METALS, BACTERIA, OIL, GREASE, AND ORGANICS.
- 27. WASH VEHICLES IN SUCH A MANNER AS TO PREVENT NON-STORM WATER DISCHARGES TO SURFACE WATERS OR DRAINAGE SYSTEMS. 28. CLEAN STREETS IN SUCH A MANNER AS TO PREVENT UNAUTHORIZED NON-STORM WATER DISCHARGES FROM REACHING SURFACE WATER OR DRAINAGE SYSTEMS.
- 29. PROVIDE EFFECTIVE SOIL COVER FOR INACTIVE AREAS AND ALL FINISHED SLOPES, OPEN SPACE, UTILITY BACKFILL, AND COMPLETED LOTS.

  30. LIMIT THE USE OF PLASTIC MATERIALS WHEN MORE SUSTAINABLE, ENVIRONMENTALLY FRIENDLY ALTERNATIVES EXIST. WHERE
- PLASTIC MATERIALS ARE DEEMED NECESSARY, THE DISCHARGER SHALL CONSIDER THE USE OF PLASTIC MATERIALS RESISTANT TO SOLAR DEGRADATION.
  31. ESTABLISH AND MAINTAIN EFFECTIVE PERIMETER CONTROLS AND STABILIZE ALL CONSTRUCTION ENTRANCES AND EXITS TO SUFFICIENTLY CONTROL EROSION AND SEDIMENT DISCHARGES FROM THE SITE.
  32. EFFECTIVELY MANAGE ALL RUN-ON, ALL RUNOFF WITHIN THE SITE AND ALL RUNOFF THAT DISCHARGES OFF THE SITE. RUN-ON
- FROM OFF SITE SHALL BE DIRECTED AWAY FROM ALL DISTURBED AREAS OR SHALL COLLECTIVELY BE IN COMPLIANCE WITH THE EFFLUENT LIMITATIONS.

  33. ALL INSPECTION, MAINTENANCE REPAIR AND SAMPLING ACTIVITIES AT THE PROJECT LOCATION SHALL BE PERFORMED OR SUPERVISED BY A QUALIFIED SWPPP PRACTITIONER. THE QSP MAY DELEGATE ANY OR ALL OF THESE ACTIVITIES TO AN EMPLOYEE
- TRAINED TO DO THE TASK(S) APPROPRIATELY, BUT SHALL ENSURE ADEQUATE DEPLOYMENT.

  34. PERFORM WEEKLY INSPECTIONS AND OBSERVATIONS, AND AT LEAST ONCE EACH 24—HOUR PERIOD DURING EXTENDED STORM EVENTS TO IDENTIFY AND RECORD BMPs THAT NEED MAINTENANCE TO OPERATE EFFECTIVELY, THAT HAVE FAILED, OR THAT COULD FAIL TO OPERATE AS INTENDED. INSPECTIORS SHALL BE THE QSP OR TRAINED BY THE QSP. COMPLETE AN INSPECTION CHECKLIST
- INCLUDING REQUIRED INFORMATION FOR EACH INSPECTION.

  35. IMPLEMENT REPAIRS OR DESIGN CHANGES TO BMPs WITHIN 72 HOURS OF IDENTIFICATION AND COMPLETE THE CHANGES AS SOON AS POSSIBLE
- 36. REFER TO STORM WATER POLLUTION PREVENTION PLAN FOR ADDITIONAL INFORMATION ON BMP'S USED FOR SITE.
  37. 100 PERCENT OF TREES, STUMPS, ROCKS AND ASSOCIATED VEGETATION AND SOILS RESULTING PRIMARILY FROM LAND CLEARING SHALL BE REUSED OR RECYCLED.

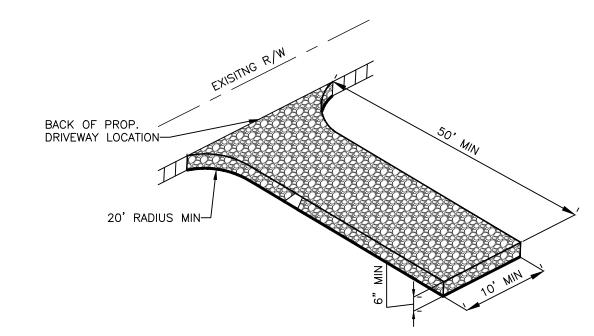

- DESIGN SPECIFICATIONS

  1. STONE APPLIED TO THE PAD WILL BE 2—INCH STONE.

  2. THE LENGTH OF THE PAD WILL NOT BE LESS THAN 50 FEET.

  3. THE THICKNESS OF THE PAD WILL A MINIMUM OF 6 INCHES.

  4. THE WIDTH OF THE PAD WILL BE A MINIMUM OF 10 FEET.

  5. FILTER FABRIC WILL BE PLACED OVER THE ENTIRE AREA
- BEFORE PLACING STONE.
- B CONSTRUCTION EXIT/ENTRANCE DETAIL

  NOT TO SCALE



N DATE BY

Moua Enterprise
Professional Engineerii
and Surveying
559-288-3217

GRADING PLAN FOR
PROPOSED POPEYE'S RESTUARA!
BRENTWOOD BLVD.
BRENTWOOD, CA 94513
APN: 016-150-106-9

DRAWN BY: PPM

PROJ. ENGR: PPM

PROJECT#

ME-321


PREPARED FOR:

SUNNY GHAI GHAI MANAGEMENT SERVICES, INC. 25 E. AIRWAY BLVD LIVERMORE, CA 94551

OSION CONTROL PLAN

SHEET NO.
4 / 5

SAVED: 12/4/202

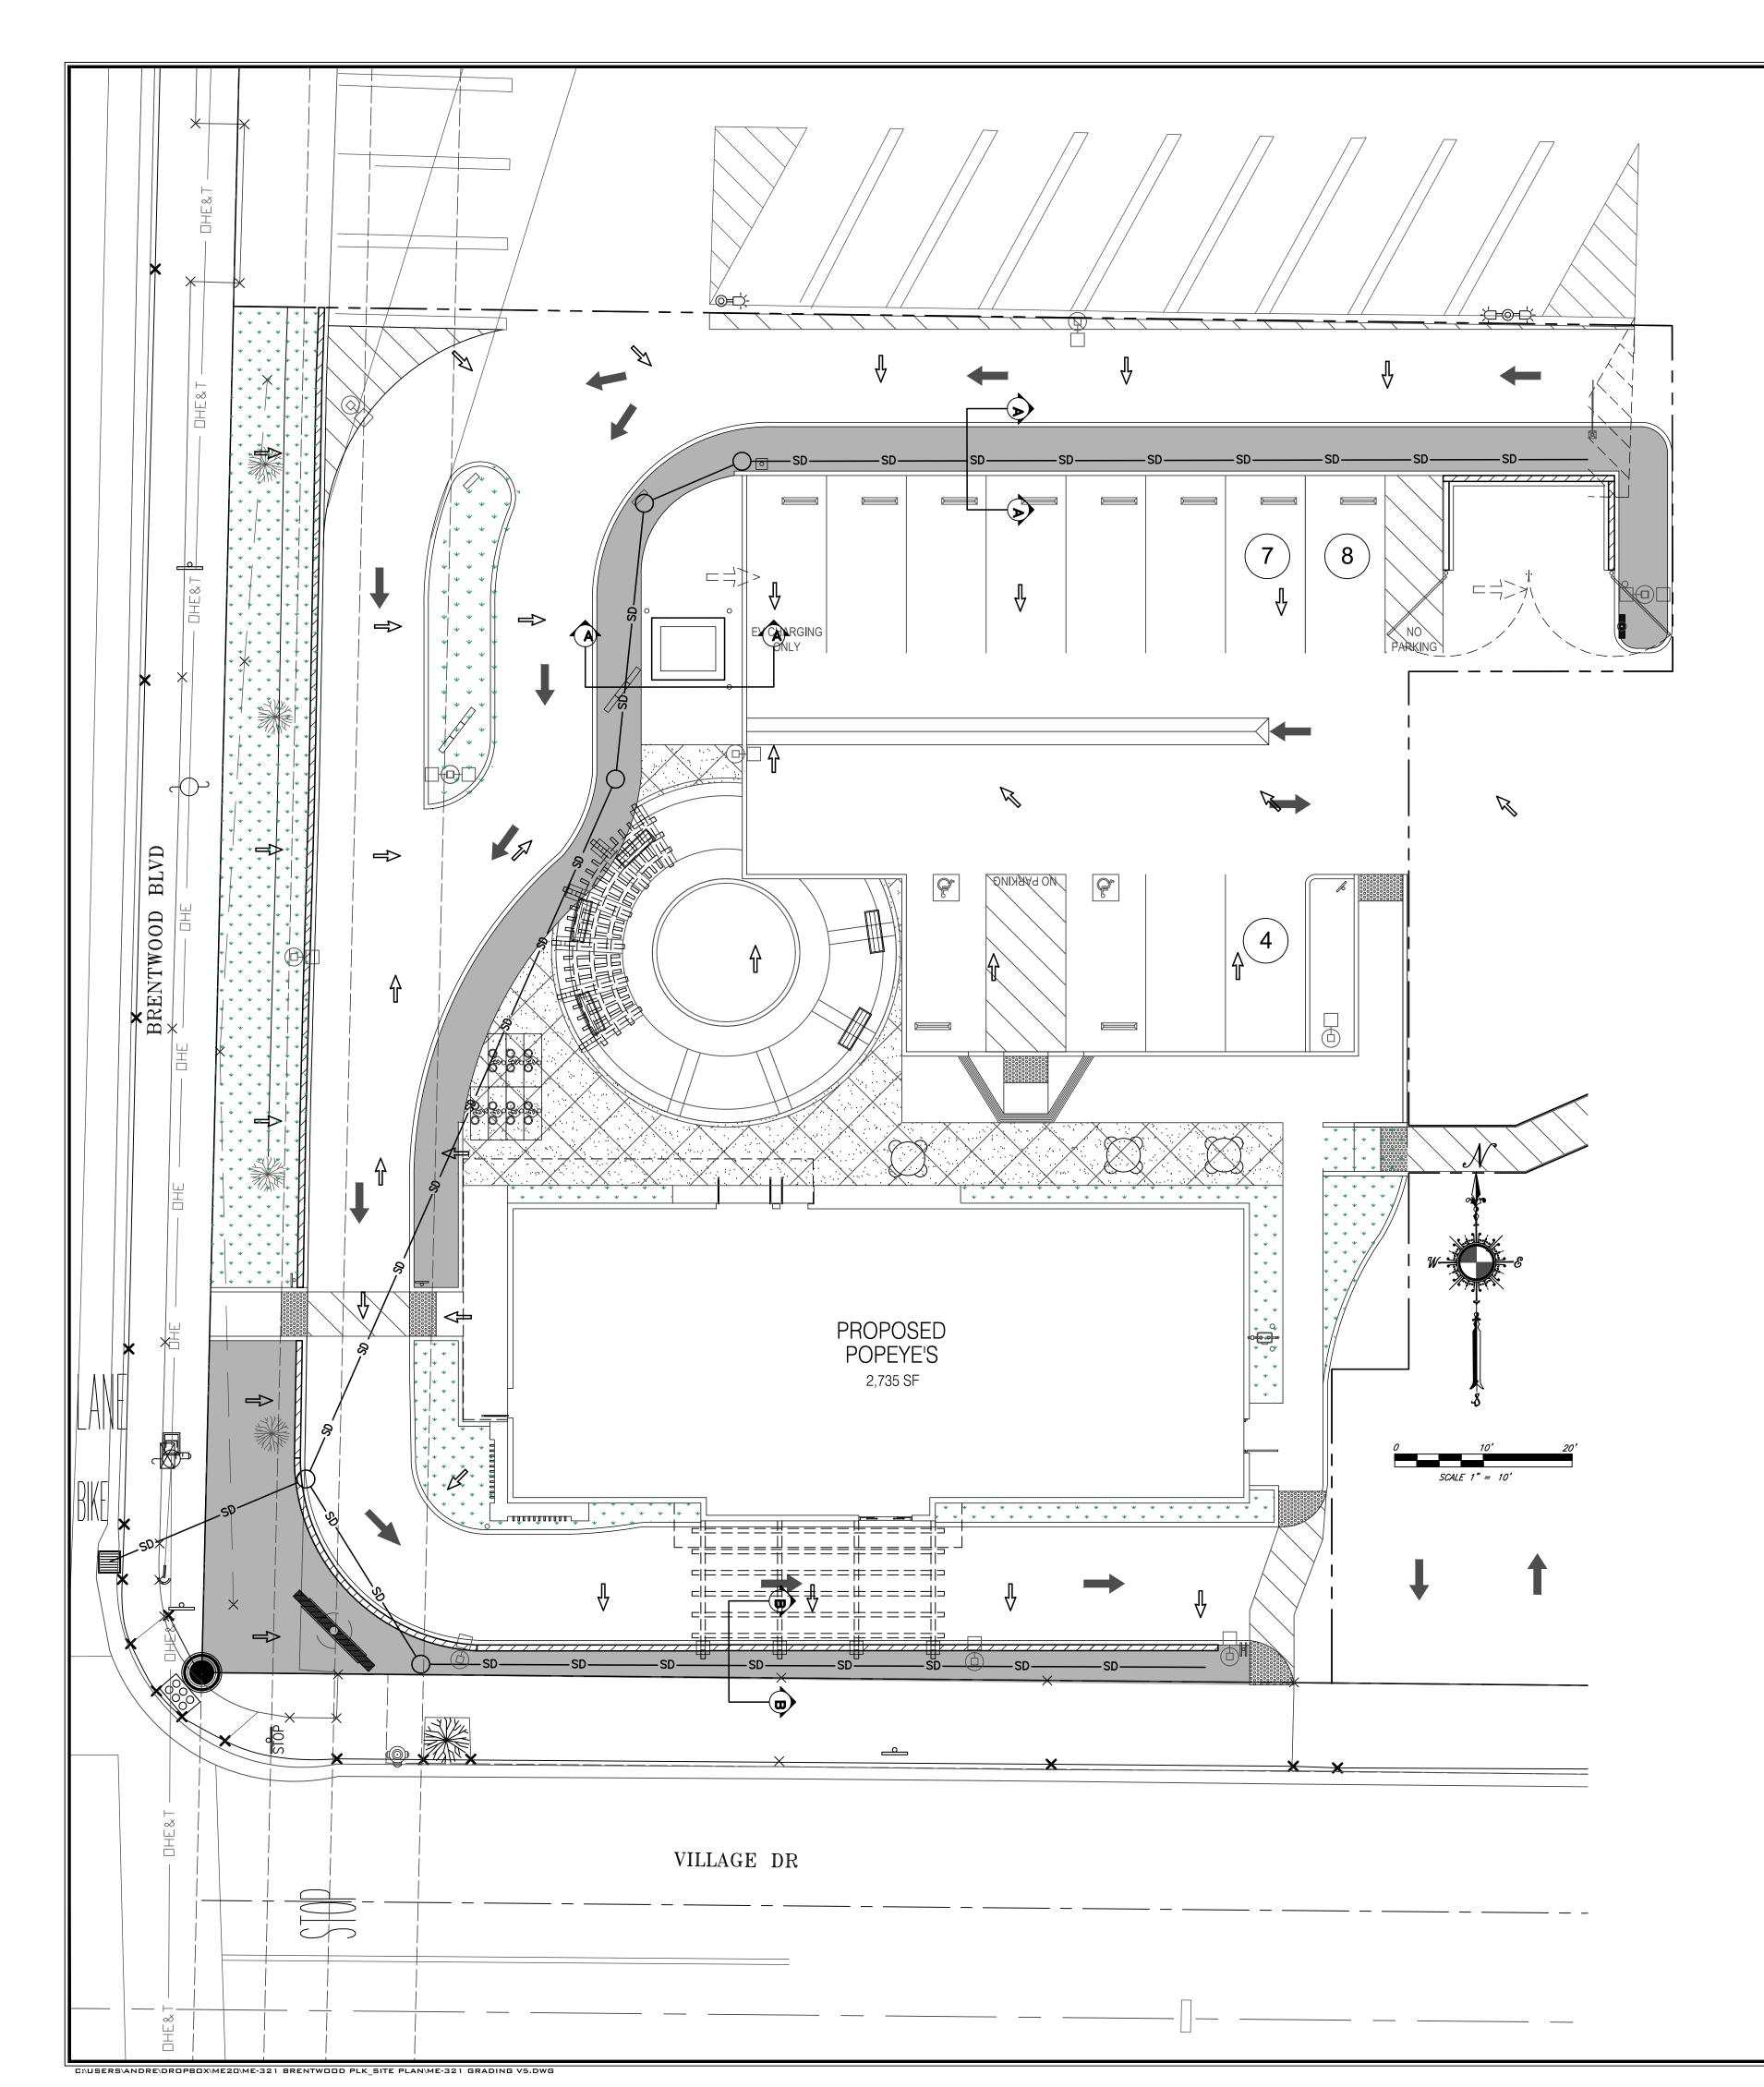

# C3 LEGEND

DRAIN MANAGEMENT AREAS (DMAs):

LANDSCAPING AREAS: DMA 1 - SELF-TREATING AREAS (2,063 SF)

BUILDING & PAVED AREAS: DMA 2 - RESTAURANT BUILDING, PARKING AREAS & DRIVE-THRU

(13,778 SF)

INTEGRATED MANAGEMENT PRACTICE (IMP): BIORETENTION BASINS (TOTAL 1,971 SF) W/1 FOOT PONDING & 2 FEET OF SUBSURFACE AGGREGATE

SITE INFORMATION:

PROJECT BOUNDARY

SURFACE FLOW DIRECTION

**Self-Treating DMAs** DMA Name DMA3 Area (sq ft) 2,313.0 IV. Areas Draining to IMPs IMP Name: IMP1
IMP Type: Bioretention Facility
Soil Group: IMP1 IMP Sizing DMA1 Minimum **Proposed Factor Adjustment** Area or Area or DMA2 10,894 Concrete or **Factor** Volume Volume Asphalt 2,038 2,038 0.050 1.150 Surface Volume **Subsurface Volume** Maximum Underdrain Flow (cfs) Orifice

NOTE: SEE SHEET 3 OF 5 FOR X—SECTIONS & VOLUME CALC.

Diameter (in)

\(\psi\) \(\psi\) \(\psi\) \(\psi\) \(\psi\)

\_\_\_\_\_\_

SHEET NO.

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PROJ. ENGR:

PROJECT# ME-321

PREPARED FOR:

DRAWN BY: PPM


SUNNY GHAI GHAI MANAGEMENT SERVICES, INC. 25 E. AIRWAY BLVD LIVERMORE, CA 94551

II drawings herein are the property of GreenDesign

SUBMITTAL -13-23 ENTITLEMENT SET COMMENTS SITE REV. SITE REV.

**PRELIMINARY** LANDSCAPE PLAN

PRELIMINARY PLANT LIST

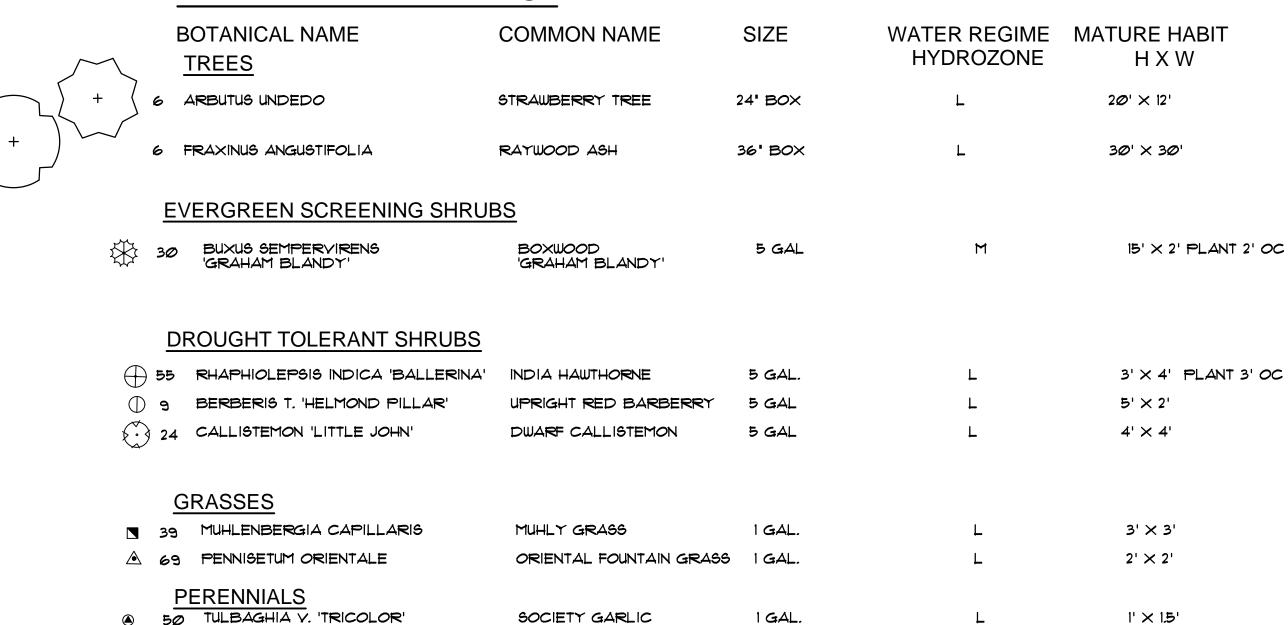

WHITE GAURA

FORT NIGHT LILY

# **PLANT NOTES:**

15 GAURA LINDHEIMERI

57 DIETES V. 'VARIEGATA'

- THE CONTRACTOR SHALL VERIFY PLANT QUANTITIES FROM THE PLANTING PLAN. QUANTITIES SHOWN IN THE LEGEND ARE FOR CONVENIENCE ONLY.
- 2. NOTIFY THE LANDSCAPE ARCHITECT IMMEDIATELY IN THE EVENT OF ANY DISCREPANCIES BETWEEN ACTUAL SITE CONDITIONS AND THE PLANTING PLAN.
- 3. SEE DETAIL AND SPECIFICATION SHEETS FOR ADDITIONAL INFORMATION.
- 5. THERE WILL BE NO MATERIALS OR PLANT MATERIALS SUBSTITUTIONS WITHOUT APPROVAL OF THE OWNER OR THE LANDSCAPE ARCHITECT.
- 6. PROVIDE POSITIVE DRAINAGE AWAY FROM ALL BUILDINGS (2% MIN.)
- 7. IN THE EVENT OF ANY DISCREPANCIES BETWEEN THIS PLAN AND ACTUAL SITE CONDITIONS, THE LANDSCAPE ARCHITECT IS TO BE NOTIFIED IMMEDIATELY.
- 8. ENTIRE SITE IS TO BE ROUGH GRADED BY THE GRADING CONTRACTOR TO WITHIN FOOT OF FINISH GRADE. LANDSCAPE CONTRACTOR IS TO FINE GRADE ALL LANDSCAPE AREAS.
- 9. ALL SITE UTILITIES ARE TO BE PROTECTED

DURING CONSTRUCTION. IN THE EVENT OF CONFLICT BETWEEN THE PLANS AND UTILITIES THE CONTRACTOR SHALL NOTIFY THE LANDSCAPE ARCHITECT. ANY DAMAGE TO UTILITIES, STRUCTURES, OR OTHER FEATURES TO REMAIN, AND CAUSED BY THE LANDSCAPE CONTRACTOR SHALL BE REPLACED OR REPAIRED BY THE CONTRACTOR AT NO EXPENSE TO THE OWNER.

 $4' \times 2'$ 

3' × 3'

10. THE WORK IN THESE DRAWINGS AND SPECIFICATIONS MY RUN CONCURRENTLY WITH WORK BY OTHERS. THE LANDSCAPE CONTRACTOR SHALL COORDINATE THE WORK WITH OTHER CONTRACTORS.

1 GAL.

1 GAL.

- II. PRIOR TO ANY DIGGING OR TRENCHING, CALL UNDERGROUND SERVICE ALERT -1.800.227.2600
- 12. MINIMUM OF 8", NON-COMPACTED TOPSOIL TO BE PROVIDED FOR ALL NEW PLANTED AREAS.
- 13. ALL NEW PLANTED AREAS TO RECEIVE 3" MIN, LAYER OF BARK MULCH. SEE PLANTING SPECIFICATIONS.

# PLANT LEGEND:

EXISTING LANDSCAPE PLANTING TO REMAIN. PROTECT AND REPAIR DURING CONSTRUCTION.



EXISTING TREE TO REMAIN

# **MULCH LEGEND:**

BARK MULCH ALL PLANTER AREAS CHIPPED OR SHREDDED WOOD FIR WASTE MULCH - PLACE 3" MIN. DEPTH 3/4"- I" DIA. COLORED DARK BROWN W/ NO VISIBLE CONTAMINANTS SHOWN

# TREE SIZE QUANTITIES

15% of all new trees to be 36 box size 30% of all new trees to be 24 box size total 36 box size trees total 24 box size trees

trees to be installed

Percentage of 36 box size trees

LANDSCAPE CALCULATIONS:

TOTAL SITE AREA: 18,705 SF/0.4 ACRE TOTAL PARKING AREA = 4,448 S.F. PARKING AREA LANDSCAPÉ REQUIRED = 311 S.F. (1% OF PARKING AREA)

|EXISTING \$TREET-

TO REMAIN

PARKING AREA LANDSCAPE PROVIDED = 393 S.F. (9%) TREES REQUIRED: 7 (16/ACRE) TREES PROVIDED = 12

PARKING AREA TREES PROVIDED = 1 TREE / 30 L.F.

TOTAL SITE LANDSCAPE AREA: 1,978 S.F. (SEE SHADE ANALYSIS SHEET L12)

1" =20'

1 1 1 1

Ø 1Ø 2Ø

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**EXISTING** 

LANDSCAPE TO

REMAIN

EXISTING TREE TO

 $\triangleleft$ 

NNN AAAANN

VILLAGE DR.

VILLAGE DR.

\_ 22 \_\_\_\_\_\_ 22 \_\_\_\_\_ 22 \_\_\_\_\_ 22 \_\_\_\_\_ 22 \_\_\_\_\_ 22 \_\_\_\_\_ 22 \_\_\_\_\_ 22 \_\_\_\_

PROPOSED

POPEYS

2,735 SF

ROOT BARRIERS WHERE TREE IS

WITHIN 8' OF CURB - TO BE SPECIFIED IN FINAL DESIGN

WATER EFFICIENT LANDSCAPE REQUIREMENTS ( TO BE PROVIDED IN PERMIT SET)

\_\_\_\_

 $\triangleleft$ 

AUTOMATIC CONTROLLER W/ ET DATA, REPEAT CYCLING IRRIGATION ZONES TO BE PER PLANT WATER REQUIREMENTS IN FINAL DESIGN RAIN SENSOR TO BE SPECIFIED

SOIL AMENDMENTS TO BE INCORPORATED PLANTER SURFACE AREAS TO BE MULCHED WATER USAGE TO MEET STATE WATER EFFICIENT LANDSCAPE STANDARD


PRELIMINARY LANDSCAPE PLAN

SCALE: 1" = 20'-0"

12-6-23 SITE REV.

PARKING AREA SHADE ANALYSIS

L1.2

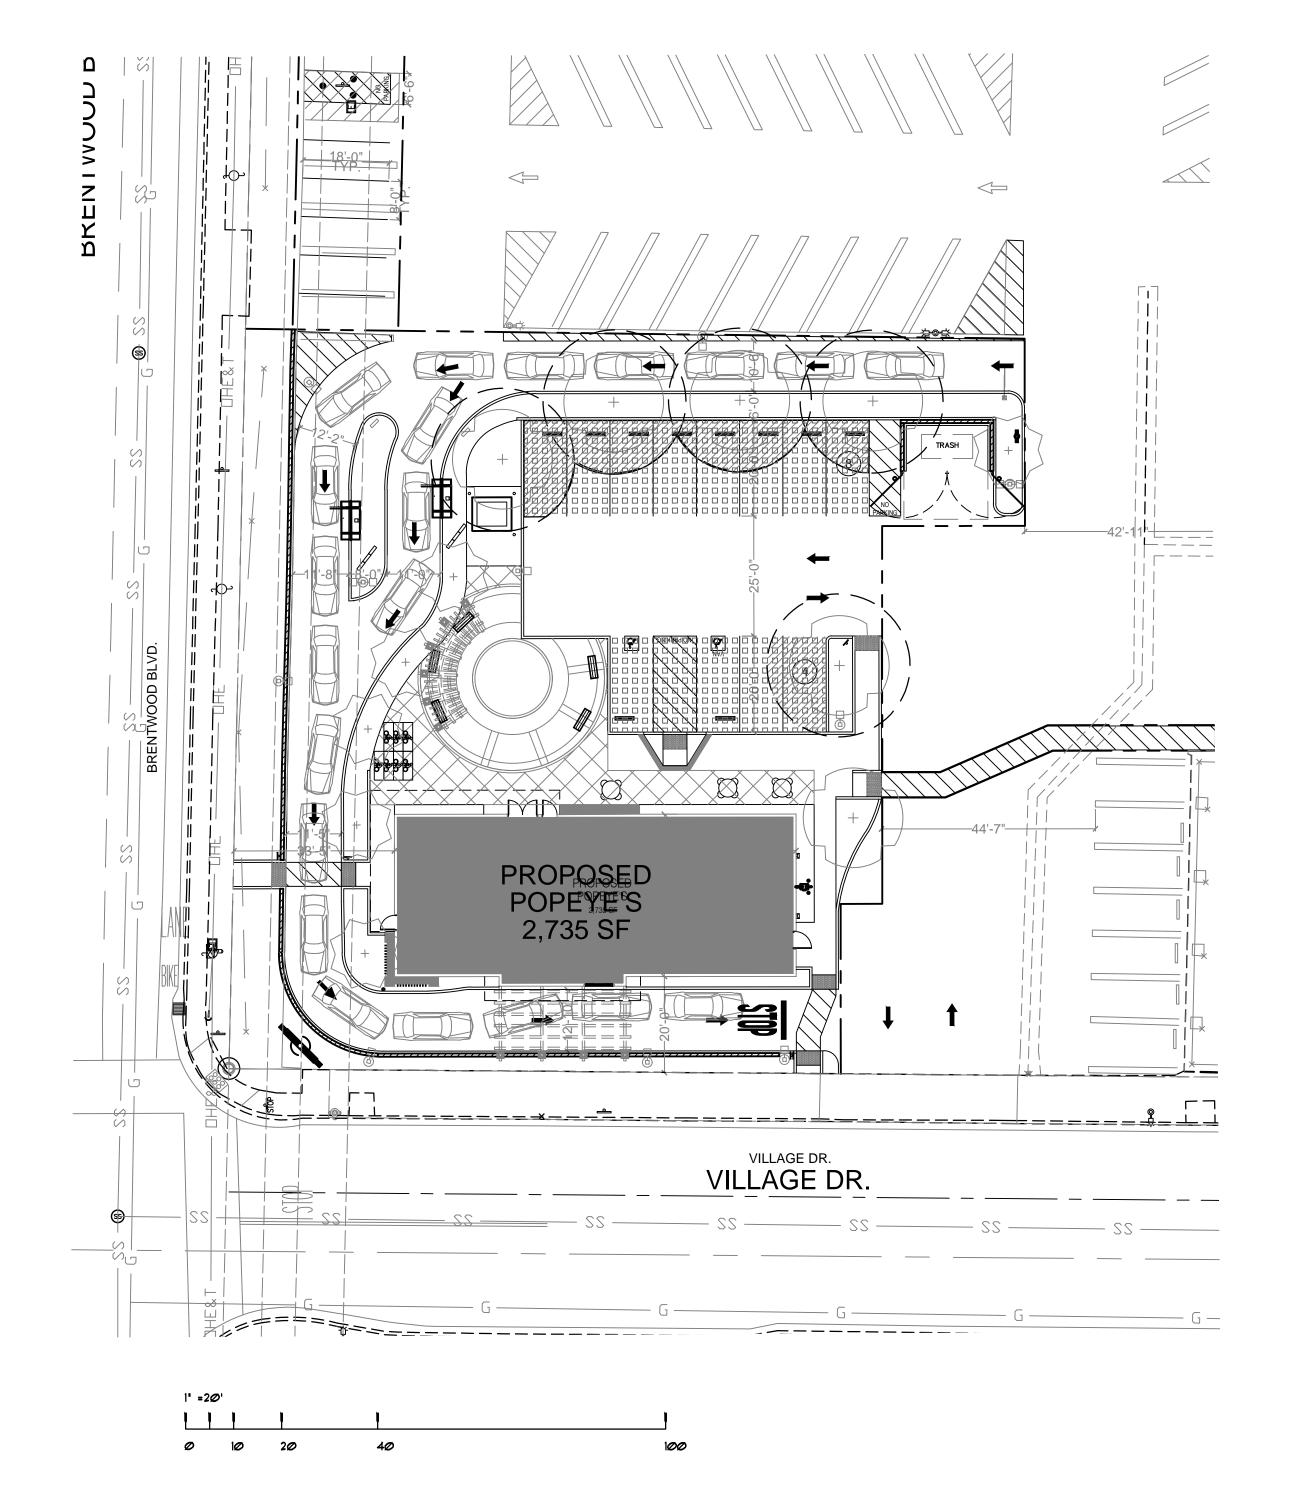


# TREE SHADING CANOPY CALCULATIONS

PARKING LOT SURFACE AREA 2,338 S.F. - total area



TREE CANOPY COVERAGE AND PARKING AREA SHADE 941 S.F. - (40% parking area) (10 year growth)

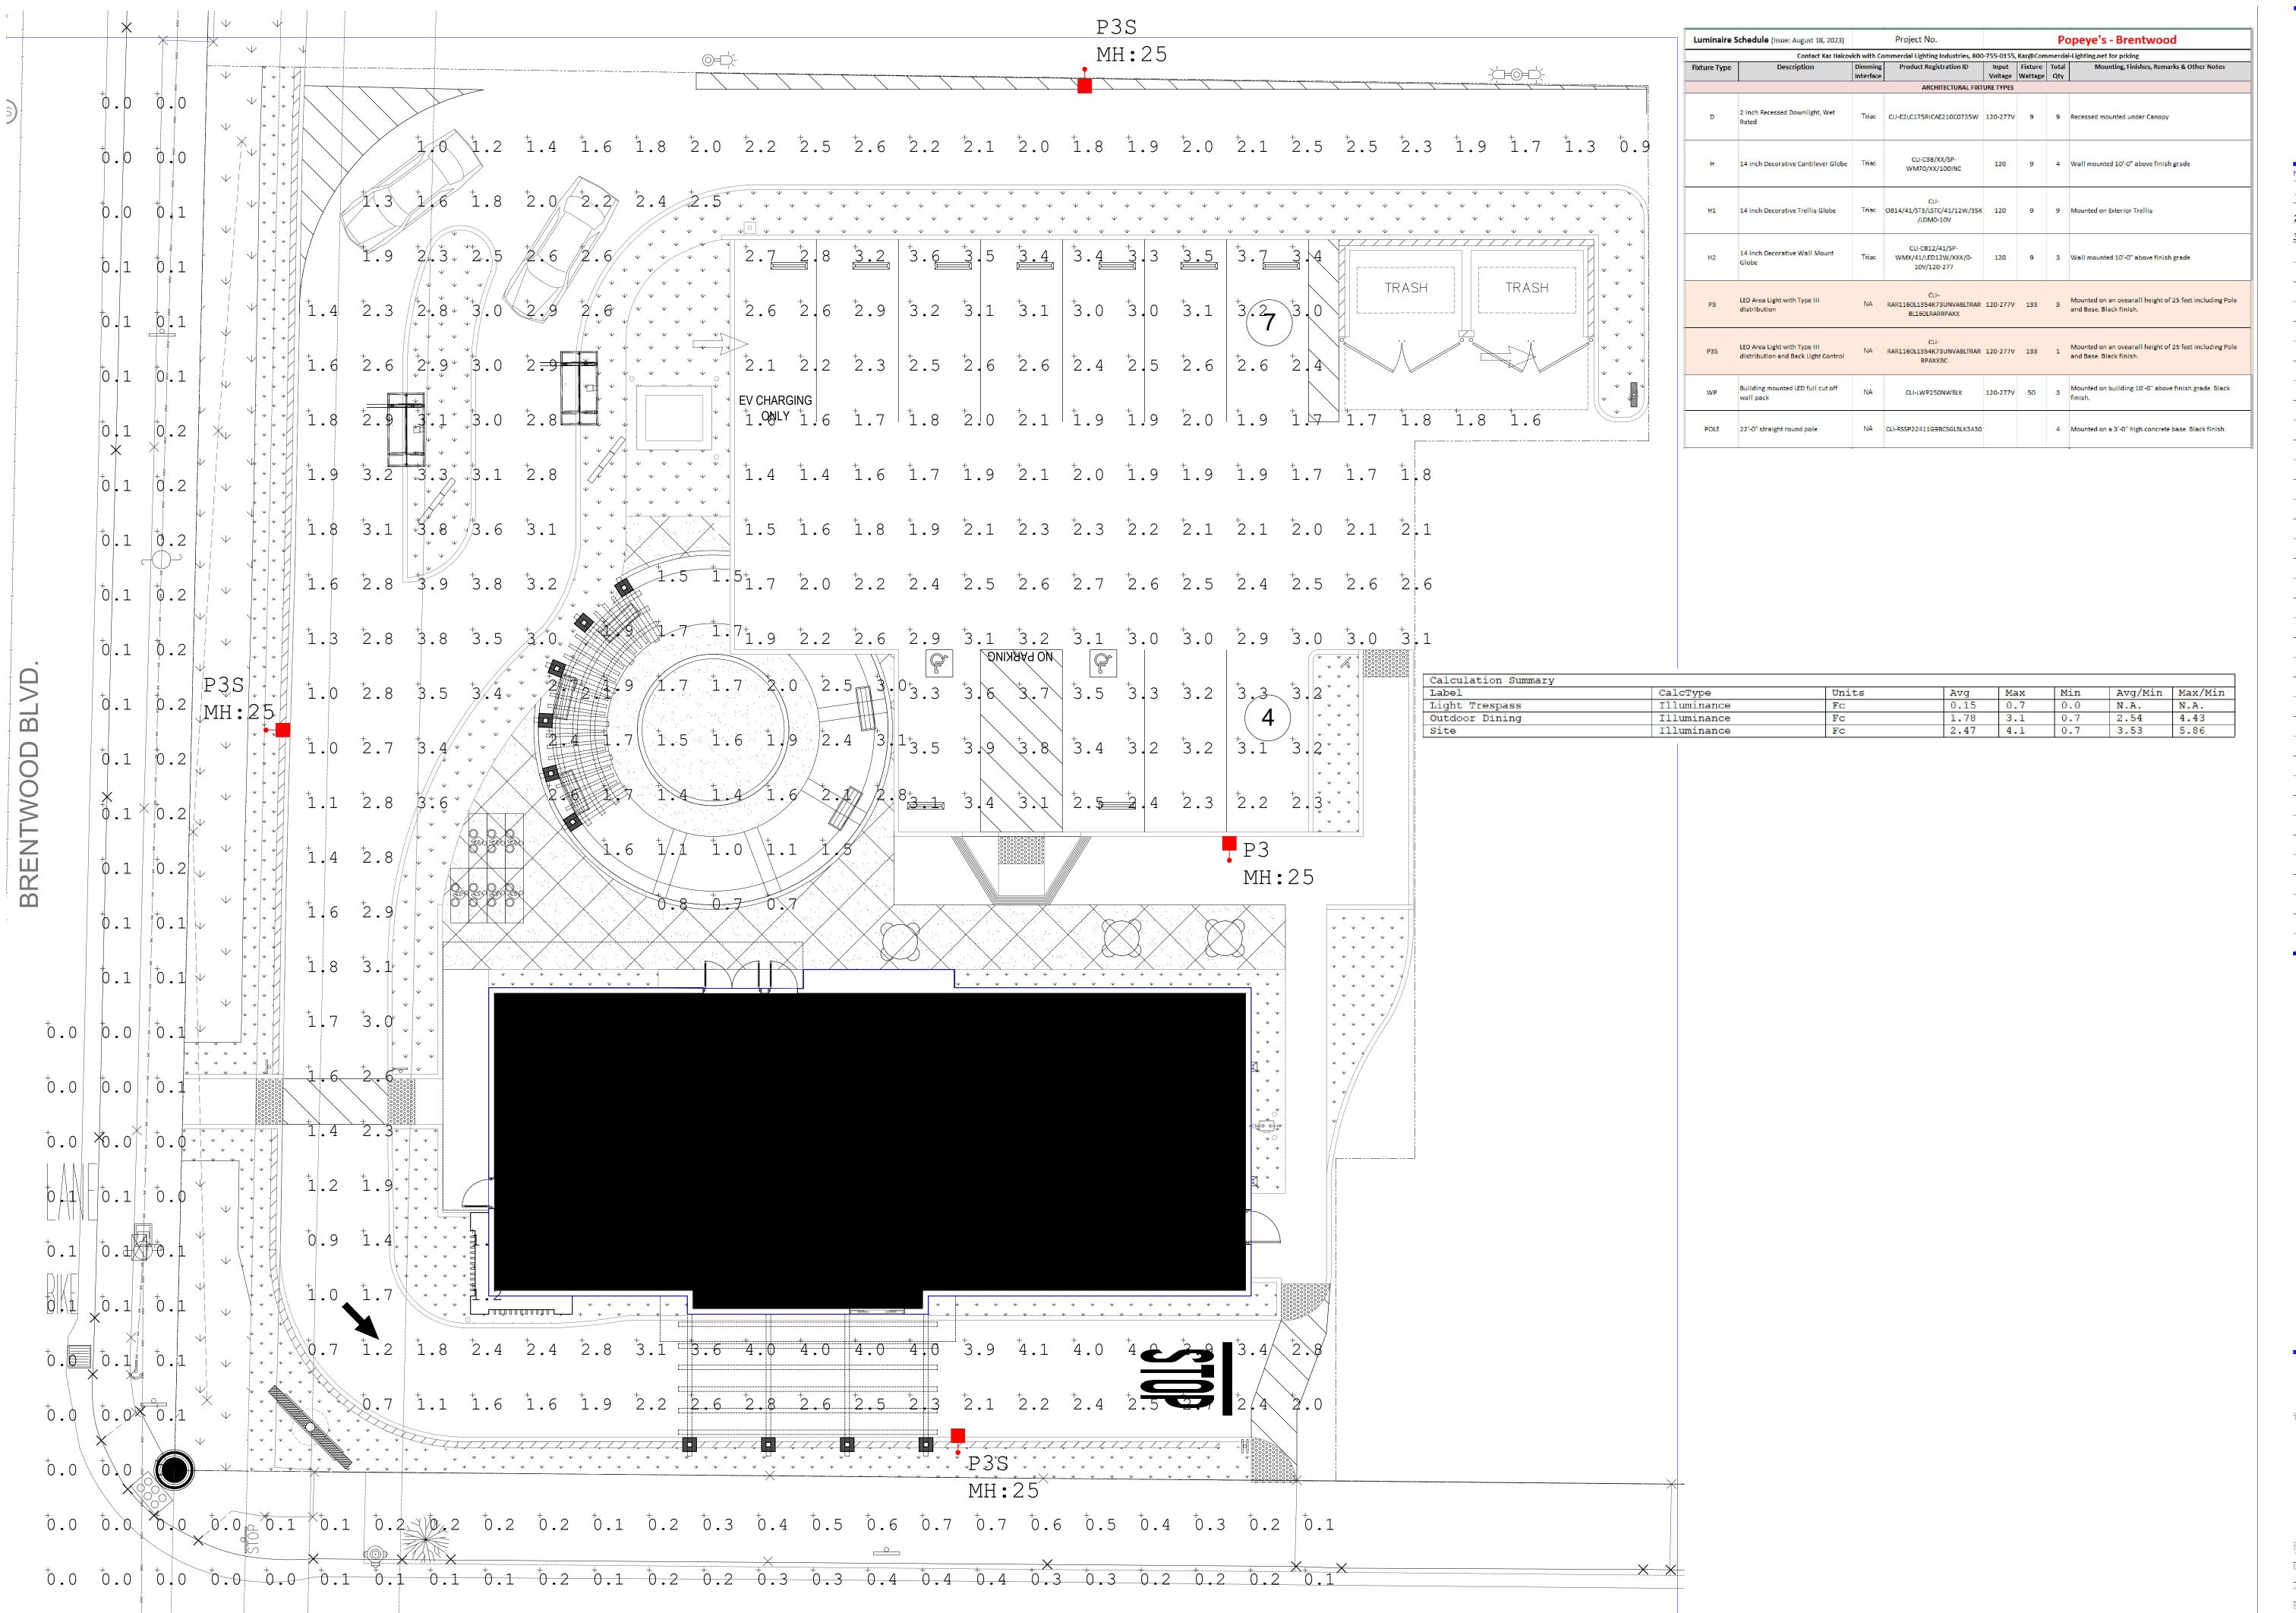

LIGHTING AND PHOTOMETRIC LAYOUT PLAN

Commercial Lighting Industries
81161 Indio Boulevard, Indio, CA 92201
Tel: 800-755-0155 | Fax: 760-262-3940

 No.
 Issue
 Date

 1
 DRAWING SUBMITTAL
 12-20-22

 2
 DRAWING SUBMITTAL
 08-18-23

 3
 DRAWING SUBMITTAL
 09-15-23

POPEYE!S

LANS AND SPECIFICATIONS ARE THE PROPERTY OF AERCIAL LIGHTING IND. DO NOT SCALE DRAWINGS. MEASUREMENTS MUST BE CHECKED ON SITE BY CONTRACTORS AND ANY DISCREPANCIES BROUGHT HE ATTENTION OF THE DESIGNER OR ARCHITECT.

SITE LIGHTING PLAN & PHOTOMETRIC DRAWING

Scale 1/16"=1'-0" 09.15.23

Drawn By Checked By I.D.

Job No.

LDE-1






ALL PLANS AND SPECIFICATIONS ARE THE PROPERTY OF COMMERCIAL LIGHTING IND. DO NOT SCALE DRAWINGS ALL MEASUREMENTS MUST BE CHECKED ON SITE B THE CONTRACTORS AND ANY DISCREPANCIES BROUGH TO THE ATTENTION OF THE DESIGNER OR ARCHITEC

Title

BUILDING MTD LIGHTING PLAN & PHOTOMETRIC DRAWING

Sheet No.

LDE-2

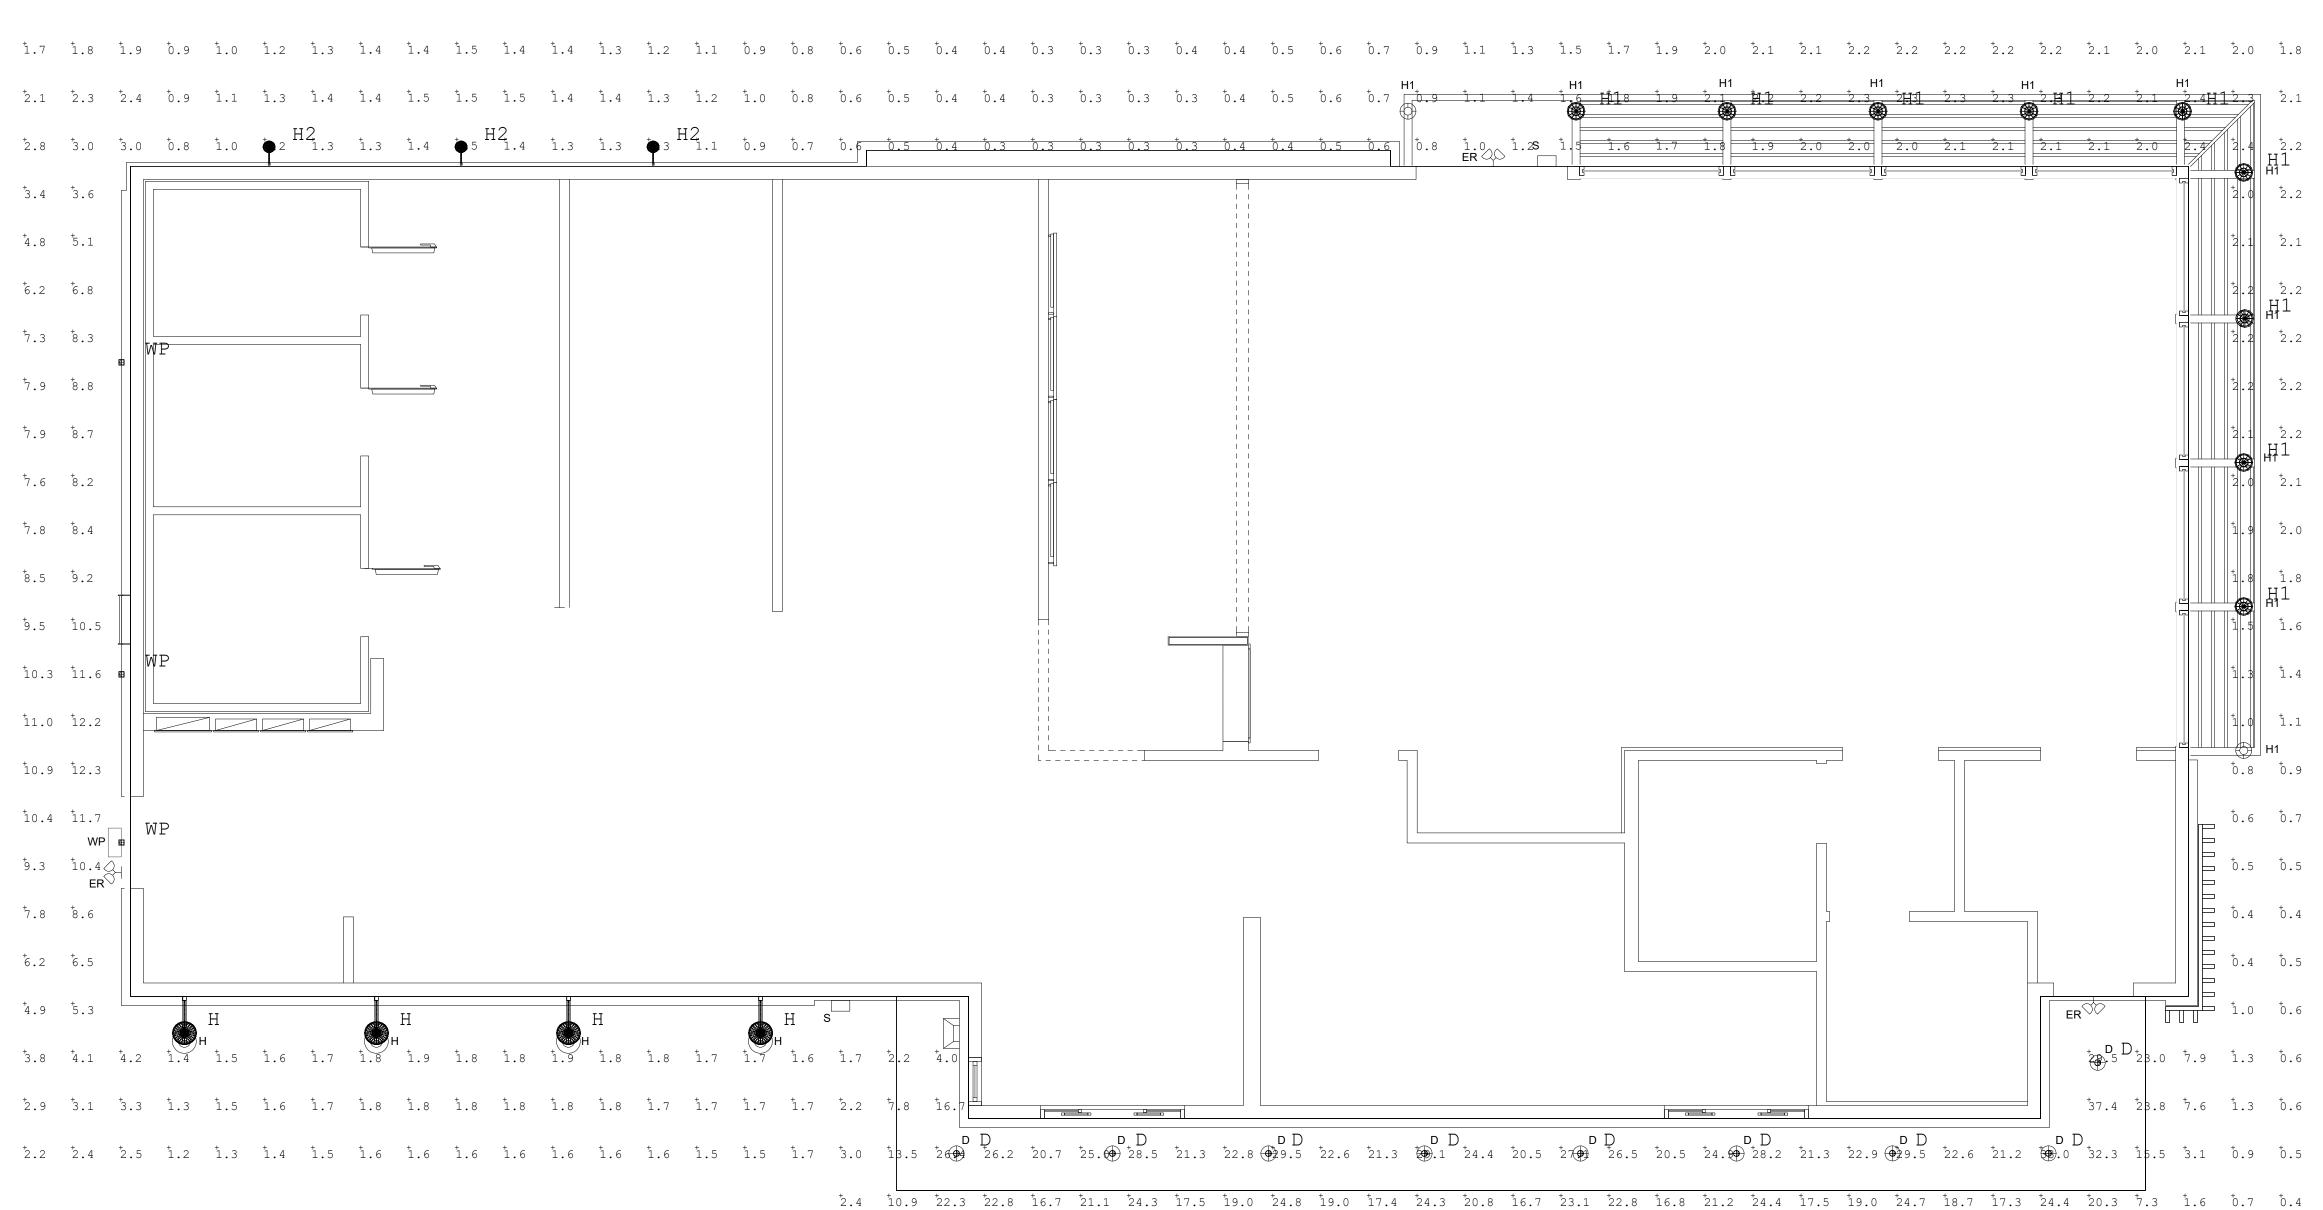

# POPPEYE'S - BRENTWOOD MAINTAINED HORIZONTAL ILLUMINANCE CALCULATIONS 12-19-22

Luminaire	Schedule					
Symbol	Qty	Label	Description	LLF	Luminaire	Luminaire
					Lumens	Watts
$\bigoplus$	9	D	4 INCH RECESSED LED DOWNLIGHT	0.950	996	14.4
	4	Н	DECORATIVE CANTILEVER GLOBE	0.950	890	9
	9	Н1	DECORATIVE TRELLIS GLOBE	0.950	890	9
	3	Н2	DECORATIVE WALL MOUNT GLOBE	0.950	890	9
	3	WP	LED WALL PACK	0.950	2672	19.4

Calculation Summary							
Label	CalcType	Units	Avg	Max	Min	Avg/Min	Max/Min
Building Perimeter	Illuminance	Fc	5.85	37.4	0.3	19.50	124.67