8. ABBREVIATIONS

AMERICANS W/ DISABILITIES ACT ADD'L ADDITIONAL ARCHITECT OR ARCHITECTURAL

BLOCKING BOTTOM CABINET CEILING CLR CLEAR CLO CLOSET

CONC CONCRETE CONT CONTINUOUS **DRYER** DOUBLE

DET DETAIL DIA DIAMETER **EXISTING ELEVATION** EACH **EQUAL**

FFL FINISH FLOOR LINE FLR **FLOOR** FINISHED GRADE LINE GYP BD GYPSUM BOARD INCLUDING MINIMUM NATURAL GRADE LINE NRTH NORTH

EXTERIOR

NOT TO SCALE ON CENTER REQ'D REQUIRED REDWOOD SHT SHEET STH SOUTH **SPECIFICATIONS** STAINLESS STEEL TO BE DETERMINED TYP **TYPICAL**

UNLESS OTHERWISE NOTED UON **VERTICAL VERT WASHER** WITH WD WOOD W/O WITHOUT WATERPROOF

9. DRAWING INDEX

1-A0.A 1. PROJECT SUMMARY & INFORMATION 2. COMPLIANCE CODES 3. PROJECT DESCRIPTION 4. SITE MAP 5. VICINITY MAP 6. GENERAL NOTES 7. PLOT PLAN 8. SYMBOLS 9. DRAWING INDEX 10. ABBREVIATIONS -A0.B DRAINAGE & UTILITY PLAN 1-A1 PROPOSED 1ST FLOOR PLAN PROPOSED 2ND FLOOR PLAN 1-A2 PROPOSED ELEVATIONS 1-A3 SECTIONS PROPOSED ROOF PLANS 1-A4 PROPOSED ADU **ELEVATIONS ROOF PLAN**

-A5 SCHEDULE OF DOORS & WINDOWS

1-E1 ELECTRICAL PLANS

1-E2 ELECTRICAL PLANS

1-P1 PLUMBING PLANS

1-P2 PLUMBING PLANS

1-A6 EXTERIOR COLOR FINISH & MATERIALS

171 KAYLA PLACE RESIDENCE RECEIVED September 23, 2024

171 KAYLA PLACE BRENTWOOD CA 94513 PARCEL #: 016-010-005


CITY OF BRENTWOOD **COMMUNITY DEVELOPMENT DEPT**



NOTES

N REVISION

5. PLOT PLAN 1. GENERAL NOTES

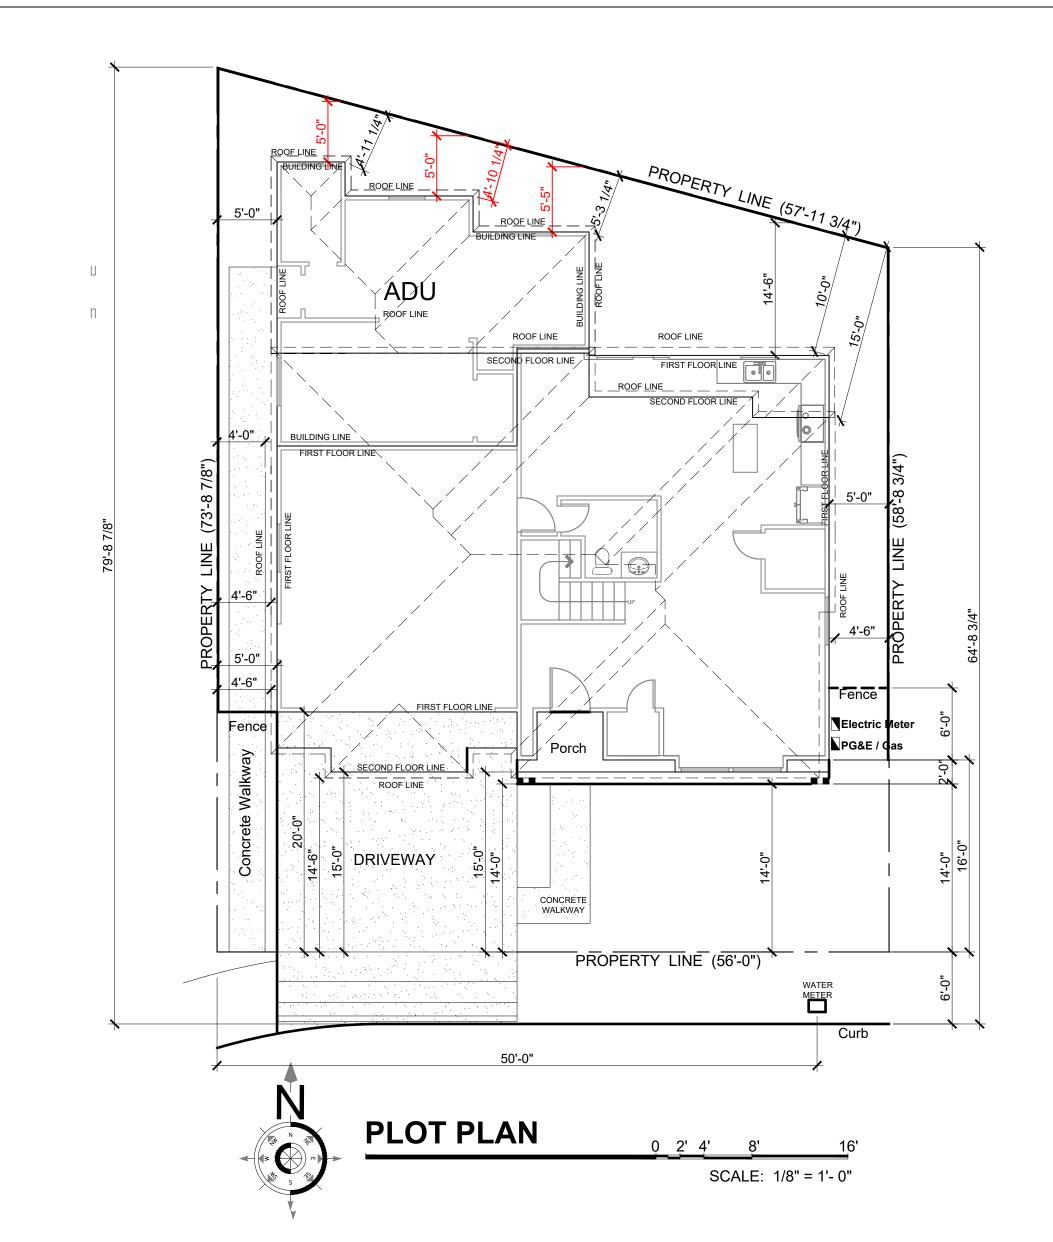

1. SEE DRAWINGS OTHER THAN STRUCTURAL FOR: TYPES OF FLOOR FINISH AND THEIR LOCATION, FOR DEPRESSIONS IN FLOOR SLABS, FOR OPENINGS IN WALLS AND FLOORS REQUIRED BY ARCHITECTURAL AND MECHANICAL FEATURES.

2. HOLES AND OPENINGS THROUGH WALLS AND FLOORS FOR DUCTS, PIPING AND VENTILATION SHALL BE COORDINATED BY THE CONTRACTOR WHO SHALL VERIFY SIZES AND LOCATION OF SUCH HOLES OR OPENINGS WITH THE MECHANICAL, PLUMBING, AND ELECTRICAL DRAWINGS AND THEIR SUB-CONTRACTORS.

3. NO PIPES OR DUCTS SHALL BE EMBEDDED IN WALLS UNLESS SPECIFICALLY DETAILED OR APPROVED BY THE ARCHITECT.

4. DRAWINGS AND SPECIFICATIONS REPRESENT FINISHED STRUCTURE CONTRACTOR SHALL BE RESPONSIBLE FOR MEANS AND METHODS OF CONSTRUCTION INCLUDING BUT NOT LIMITED TO SHORING AND TEMPORARY BRACING. THE CONTRACTOR SHALL TAKE ALL NECESSARY MEASURES TO INSURE SAFETY OF ALL PERSONS AND STRUCTURES AT THE SITE AND ADJACENT TO THE SITE. OBSERVATION VISITS TO THE SITE BY THE ARCHITECT, ENGINEER OR CONSTRUCTION MANAGER SHALL NOT RELIEVE THE CONTRACTOR OF SUCH RESPONSIBILITY.

5. CONTRACTOR SHALL VERIFY ALL DIMENSIONS AT JOB SITE BEFORE COMMENCING WORK AND SHALL REPORT ANY DISCREPANCIES TO THE

6. OMISSIONS OR CONFLICTS BETWEEN VARIOUS ELEMENTS OF THE DRAWINGS, NOTES, AND DETAILS SHALL BE BROUGHT TO THE ATTENTION OF THE ARCHITECT AND RESOLVED BEFORE PROCEEDING WITH THE WORK.

7. DO NOT USE SCALED DIMENSIONS; USE WRITTEN DIMENSIONS. WHERE NO DIMENSION IS PROVIDED, CONSULT THE ARCHITECT FOR CLARIFICATION BEFORE PROCEEDING WITH WORK.

8. IF CERTAIN FEATURES ARE NOT FULLY SHOWN OR CALLED FOR ON THE DRAWINGS OR SPECIFICATIONS, THEIR CONSTRUCTION SHALL BE OF THE SAME CHARACTER AS FOR SIMILAR CONDITIONS THAT ARE CALLED FOR OR SHOWN.

2. PROJECT DESCRIPTION

1. PROPOSED 2-STOREY RESIDENTIAL WITH ADU

3. COMPLIANCE CODES

THE CONTRACTOR AND HIS SUBCONTRACTORS SHALL CONFORM TO THE FOLLOWI BUILDING CODES AND STANDARDS AS APPLICABLE:

~ CALIFORNIA BUILDING CODE, 2022 EDITION

~ CALIFORNIA ELECTRICAL CODE, 2022 EDITION

~ CALIFORNIA CALIFORNIA MECHANICAL CODE, 2022 EDITION ~ CALIFORNIA CALIFORNIA PLUMBING CODE, 2022 EDITION

~ CALIFORNIA TITLE 24 DISABLED AND ENERGY REGULATIONS, 2022 EDITION

~ CITY OF RICHMOND MUNICIPAL CODE ~ CFC (CALIFORNIA FIRE CODE)

~ CA GREEN BUILDING STANDARD CODES, 2022 EDITION

DO NOT SCALE DRAWINGS. VERIFY ALL DIMENSIONS AT JOBSITE AND BRING ALL CONFLICTING INFORMATION TO THE ATTENTION OF THE ARCHITECT BEFORE PROCEEDING WITH THE WORK

4. PROJECT SUMMARY AND INFORMATION

PROPERTY OWNER **ADDRESS** TEL. NUMBER

STEVE MATTHIAS : 171 KAYLA PLACE, BRENTWOOD, CA

: 016-010-005 ZONING : R1 (SINGLE FAMILY DWELLING) COUNTY : CONTRA COSTA

OCCUPANCY TYPE OF CONSTRUCTION: VB

LOT AREA : 3,702 SQ.FT **GARAGE AREA** : 430 SQ.FT. AREA OF FIRST FLOOR 867 SQ.FT AREA OF SECOND FLOOR : 1,486 SQ.FT : 2,353 SQ.FT TOTAL LIVING AREA AREA OF ADU 480 SQ.FT. **COVERED PORCH** : 38 SQ.FT.

MAIN BUILDING FOOTPRINT : 1,486 SQ.FT : 480 SQ.FT. ADU BUILDING FOOTPRINT (N/A) TOTAL FOOTPRINT : 1,556 SQ.FT PERCENTAGE OF BUILDING FOOTPRINT: 42.03 %


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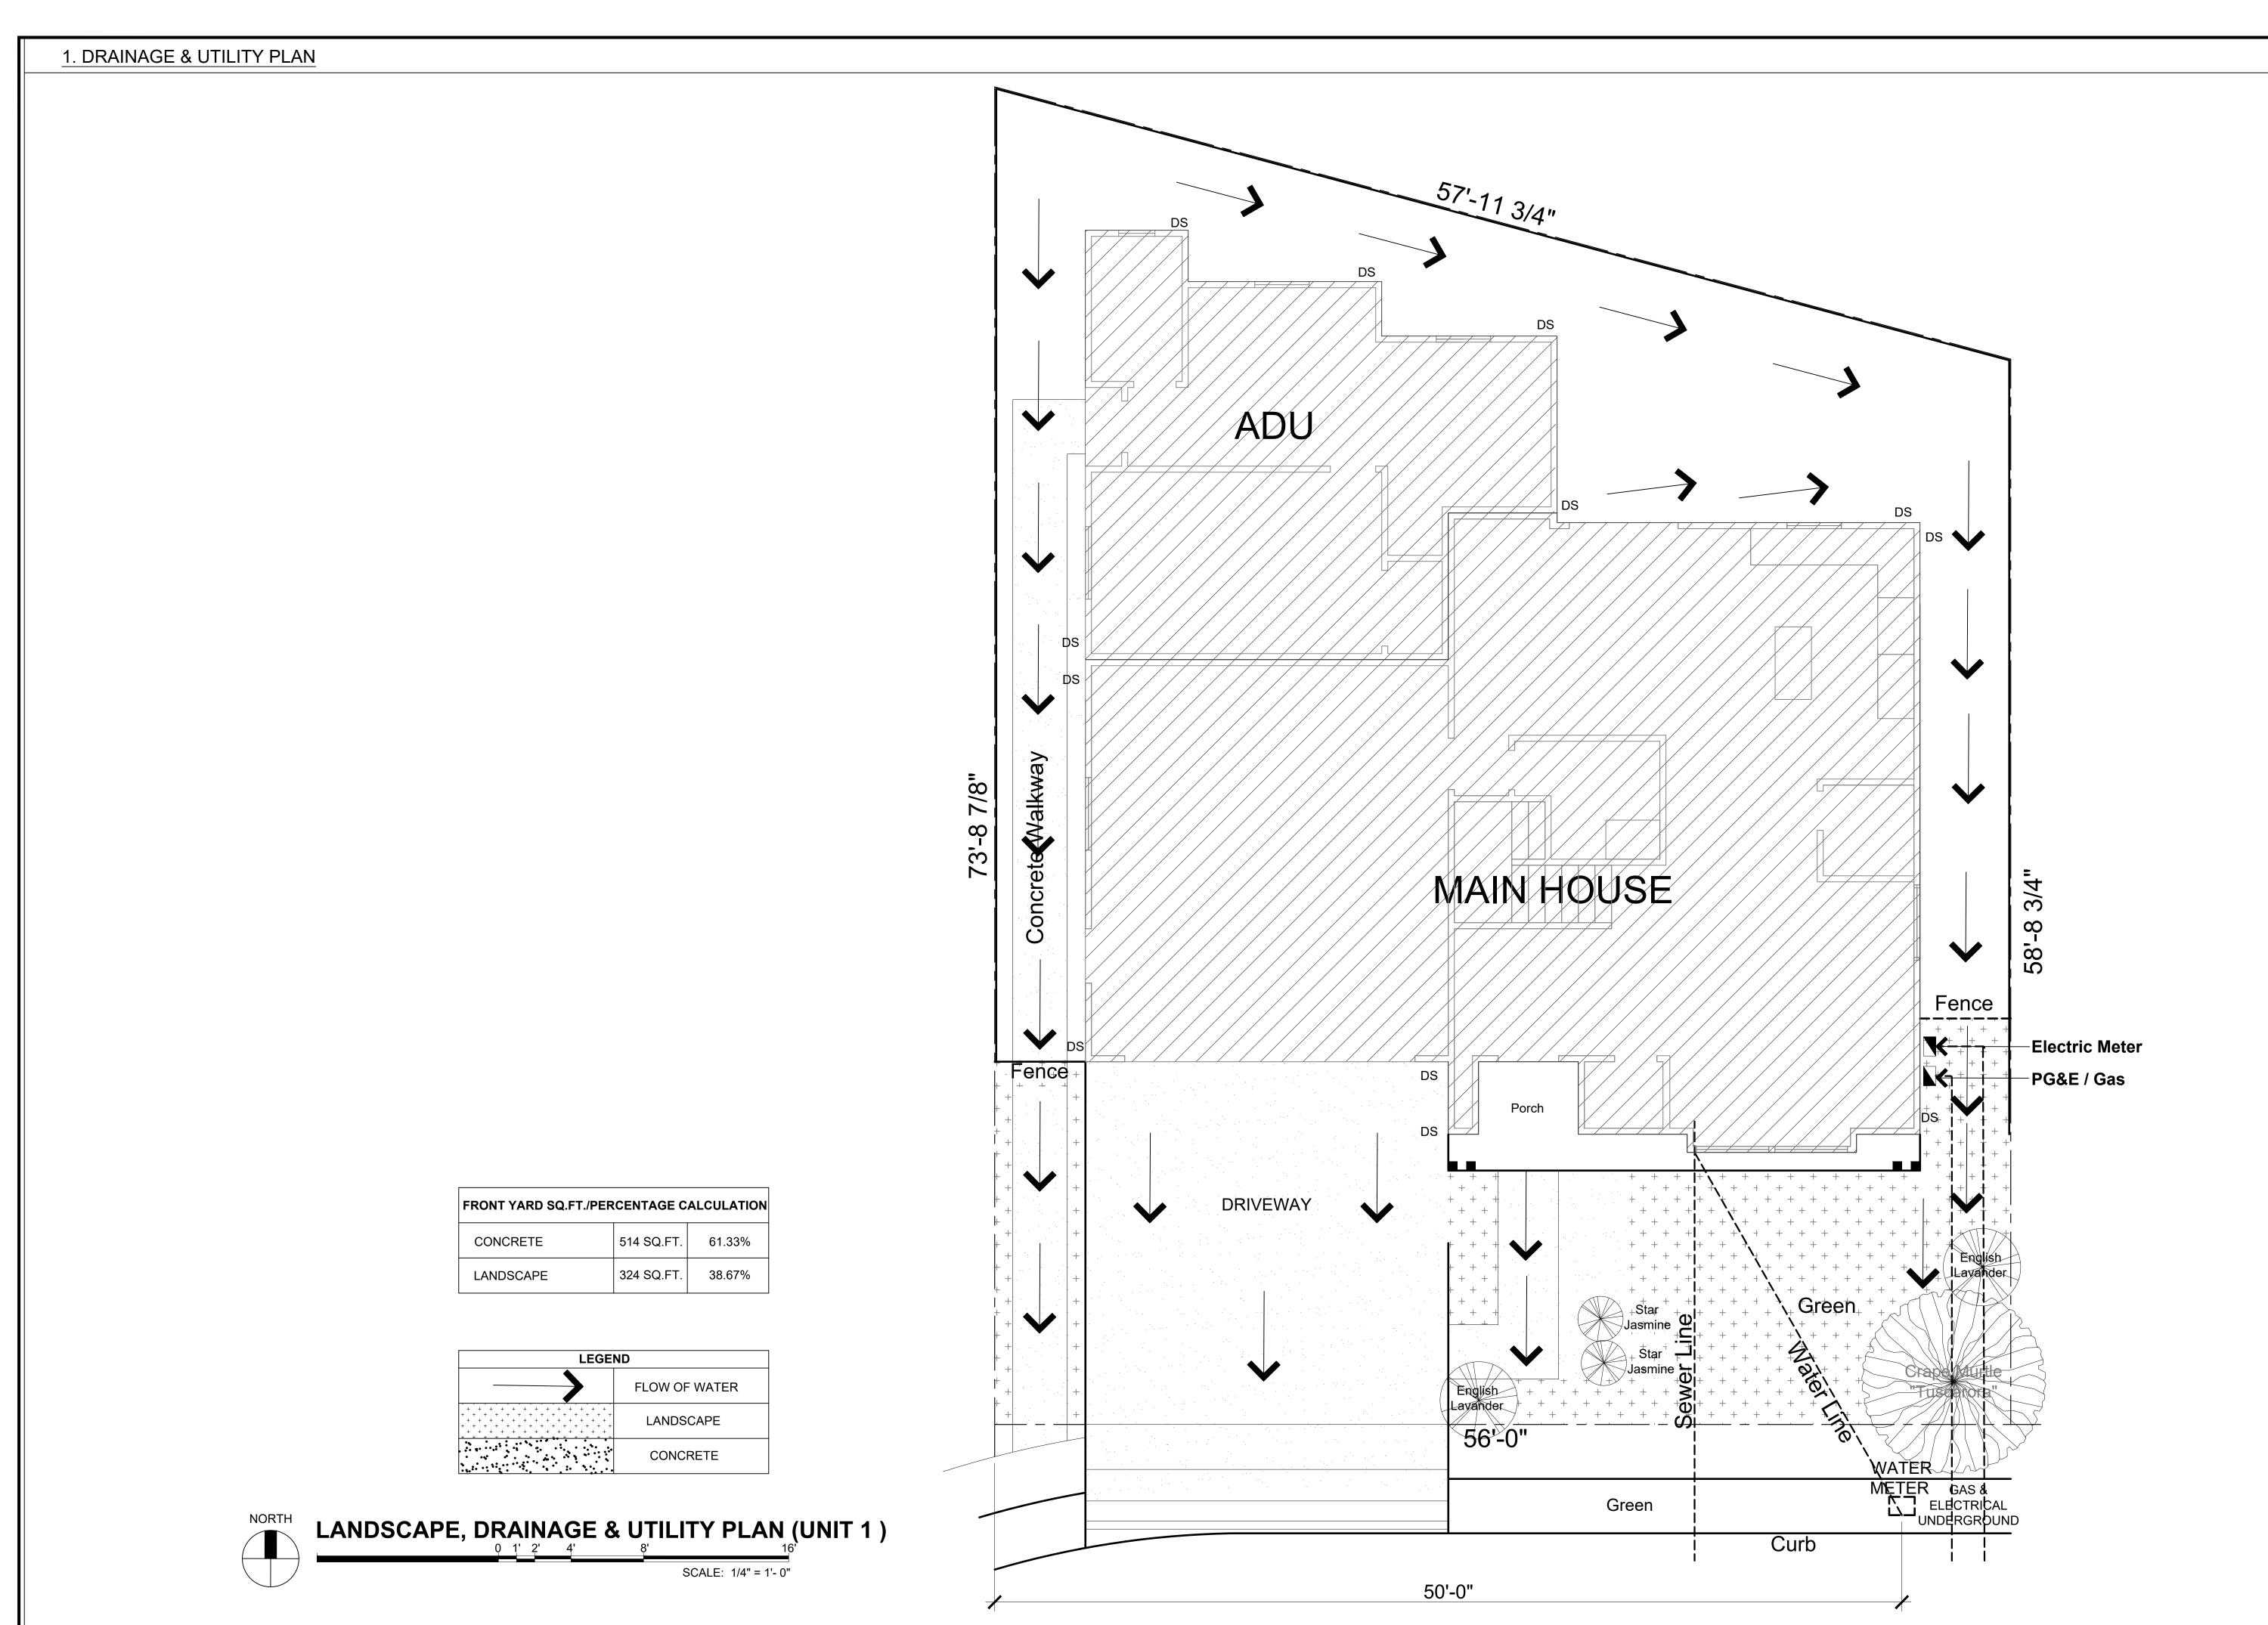
DATE

- 1		
	PROJECT	KAYLA'S PLACE RESIDENCE
	OWNER	STEVE MATTHIAS
	ADDRESS	171 KAYLA PLACE BRENTWOOD, CALIFORNIA
	CONTENT	COVER SHEET
	SCALE	SCALE
	DRAWN BY	MD
	DATE	3/15/22
	PROJECT#	_

10. SYMBOLS AND **ANGLE CENTERLINE PERPENDICULAR** POUND OR NUMBER **WORK POINT COLUMN GRID** DOOR SYMBOL WINDOW SYMBOL SHEARWALL SYMBOL -SELECTION NUMBER -SHEET NUMBER **INTERIOR ELEVATION SYMBOL**

SHEET NUMBER



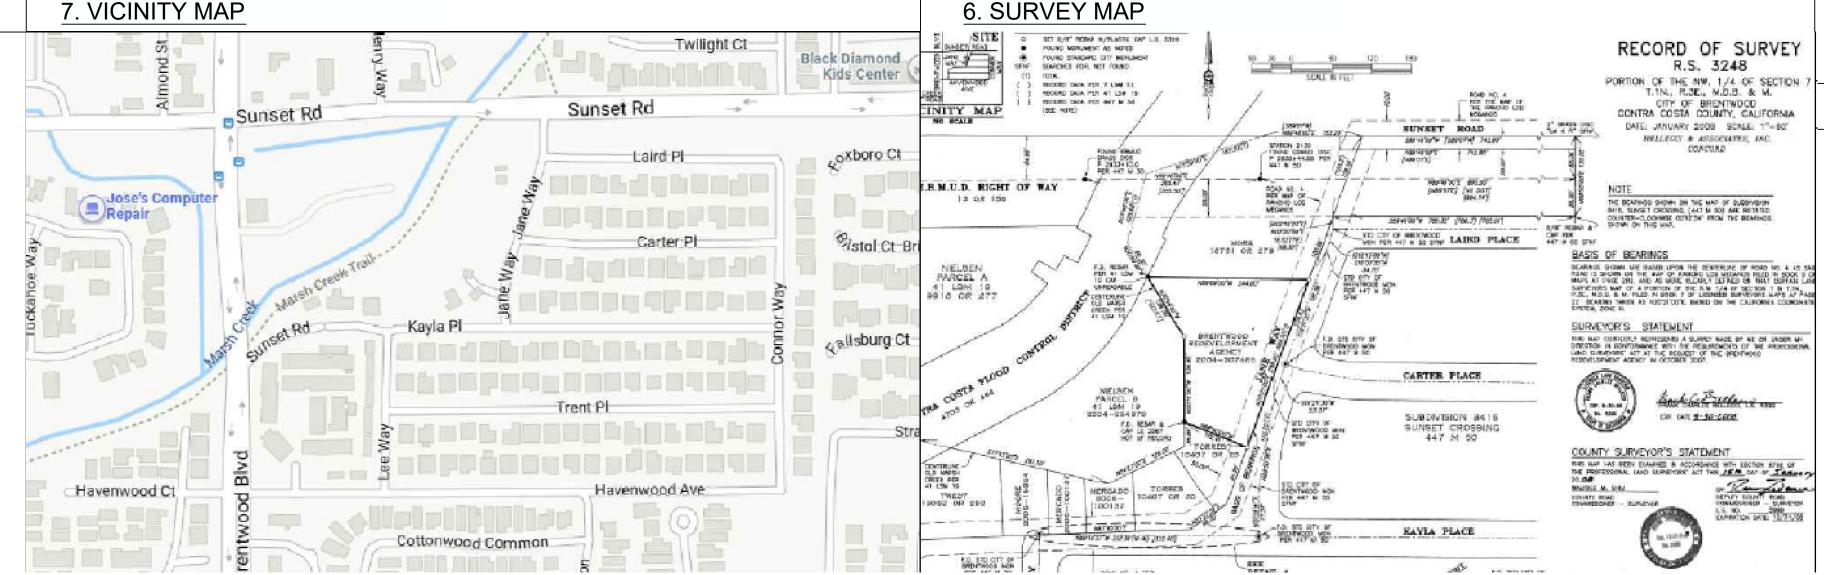




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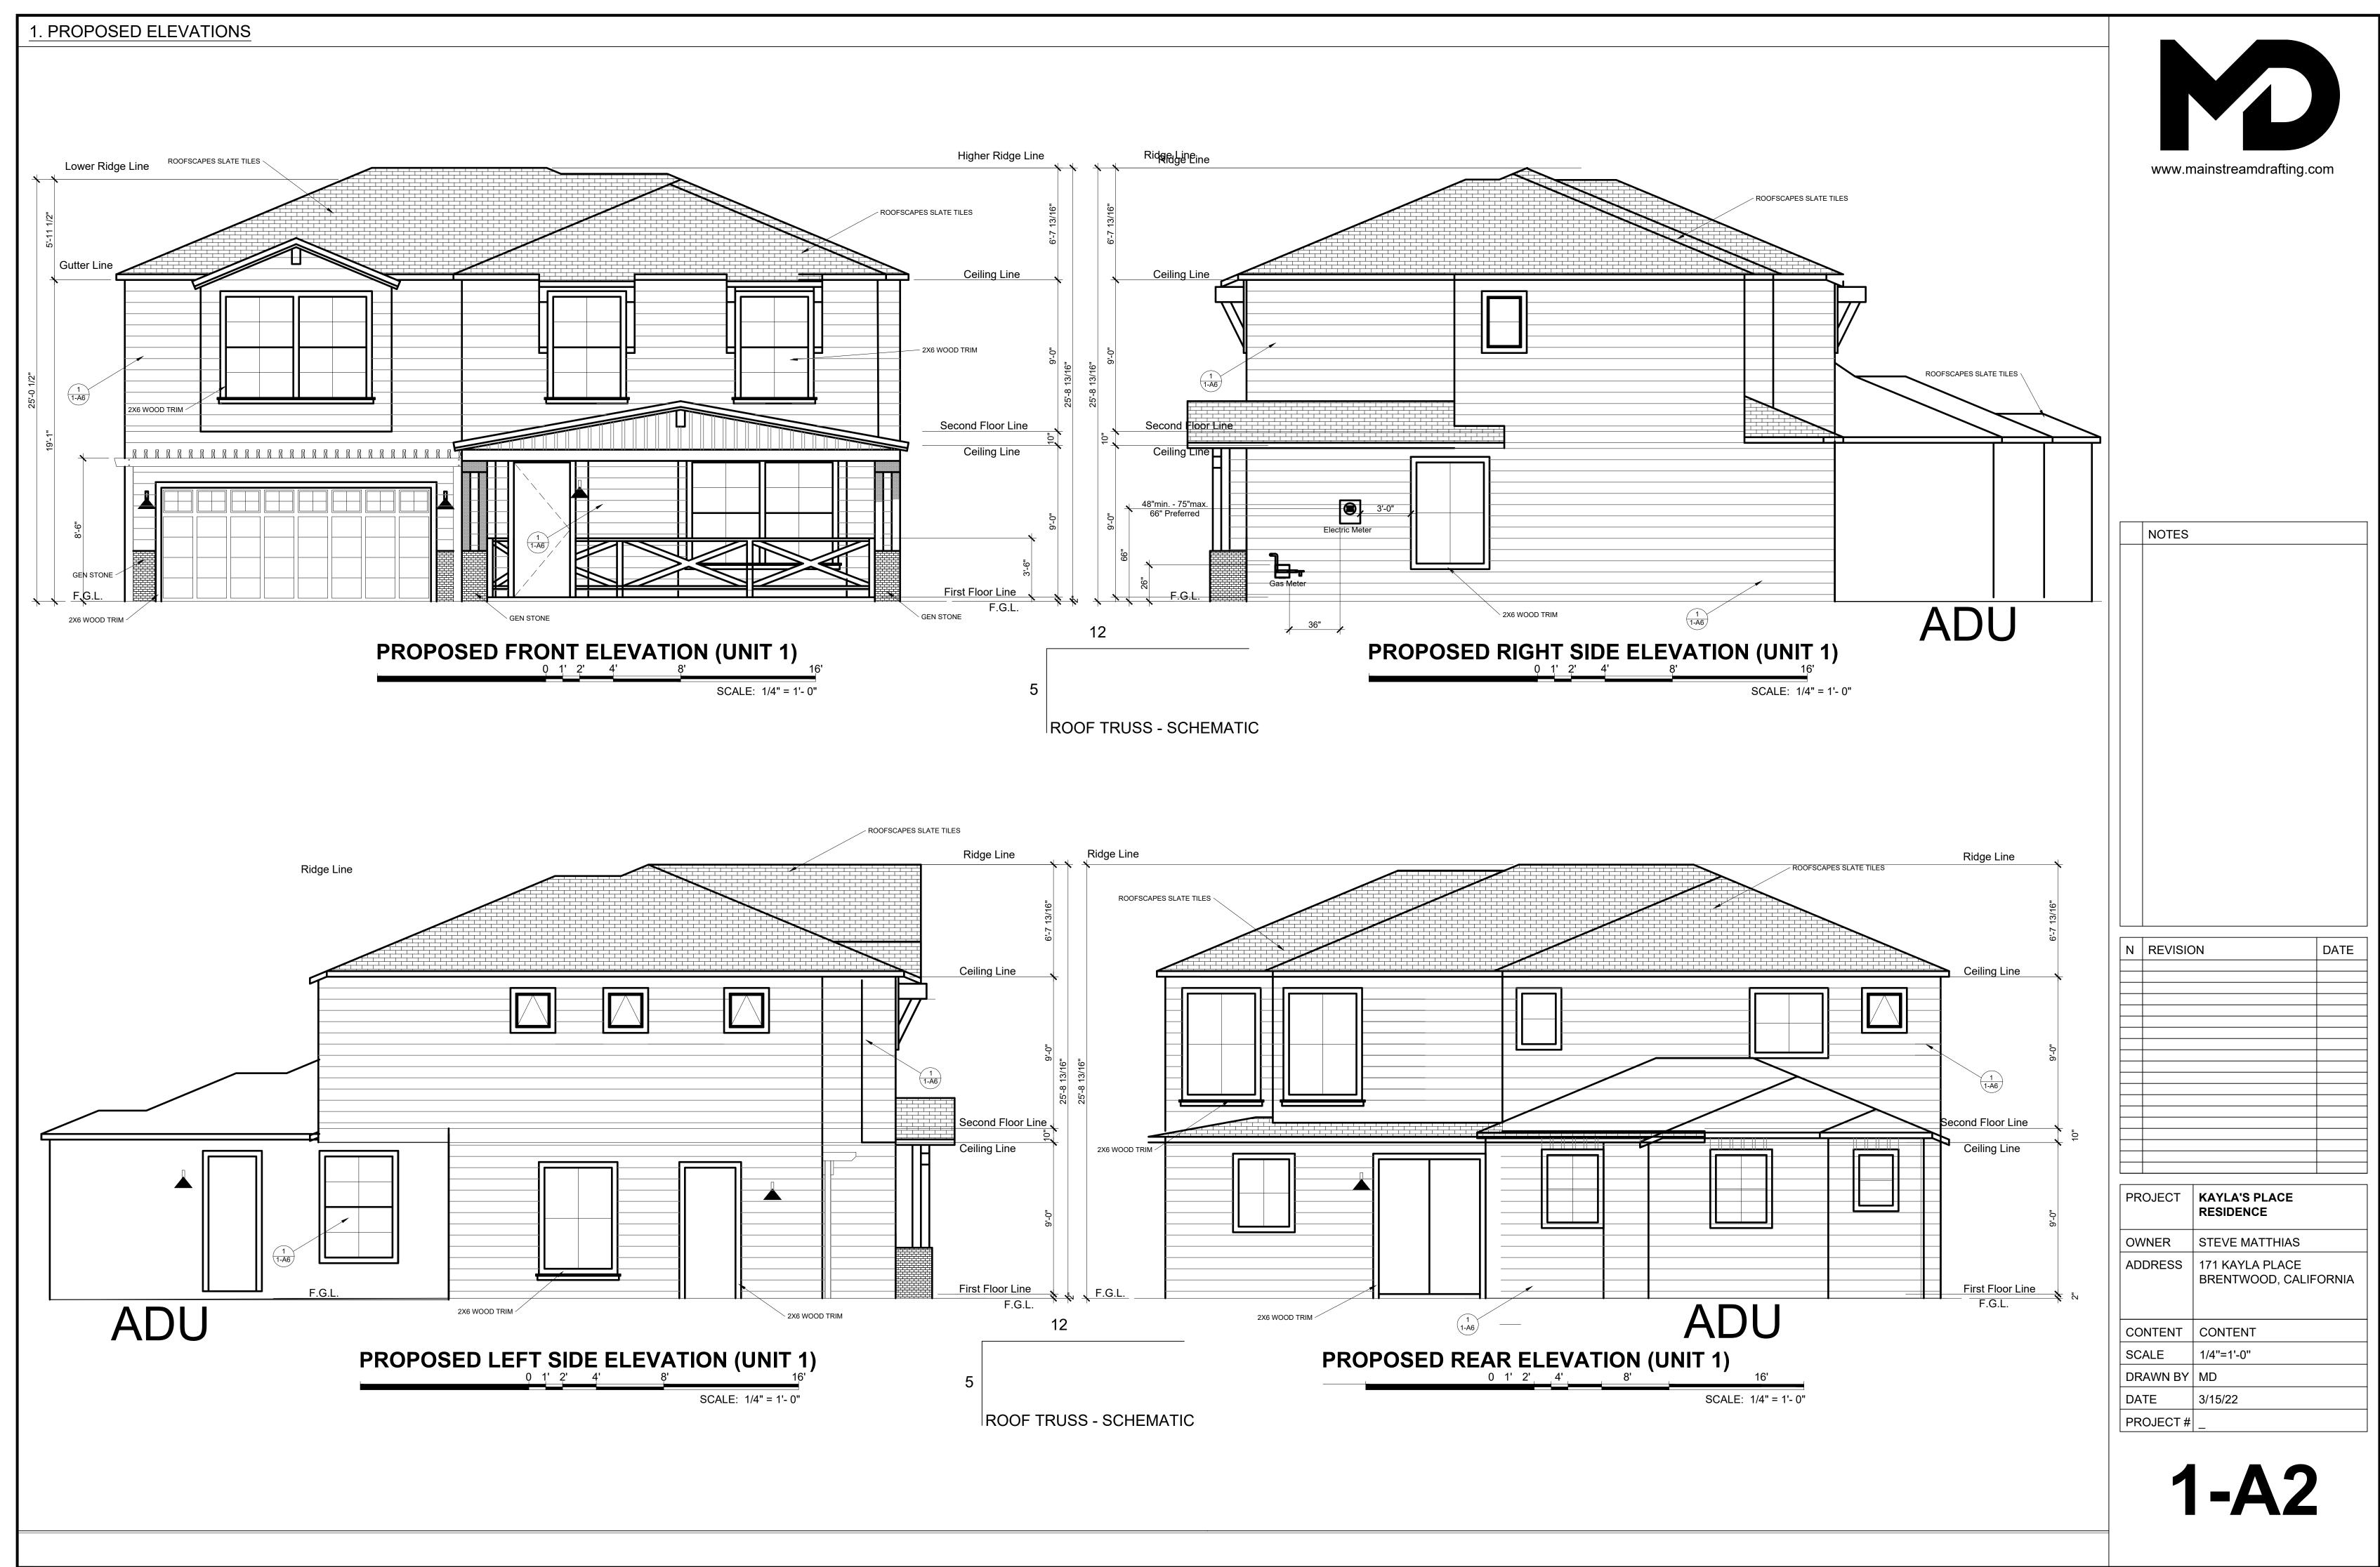
N	REVISION	DATE

PROJECT	KAYLA'S PLACE RESIDENCE
OWNER	STEVE MATTHIAS
ADDRESS	171 KAYLA PLACE BRENTWOOD, CALIFORNIA
CONTENT	DRAINAGE PLAN
SCALE	1/4"=1'-0"
DRAWN BY	MD
DATE	3/15/22
PROJECT#	_


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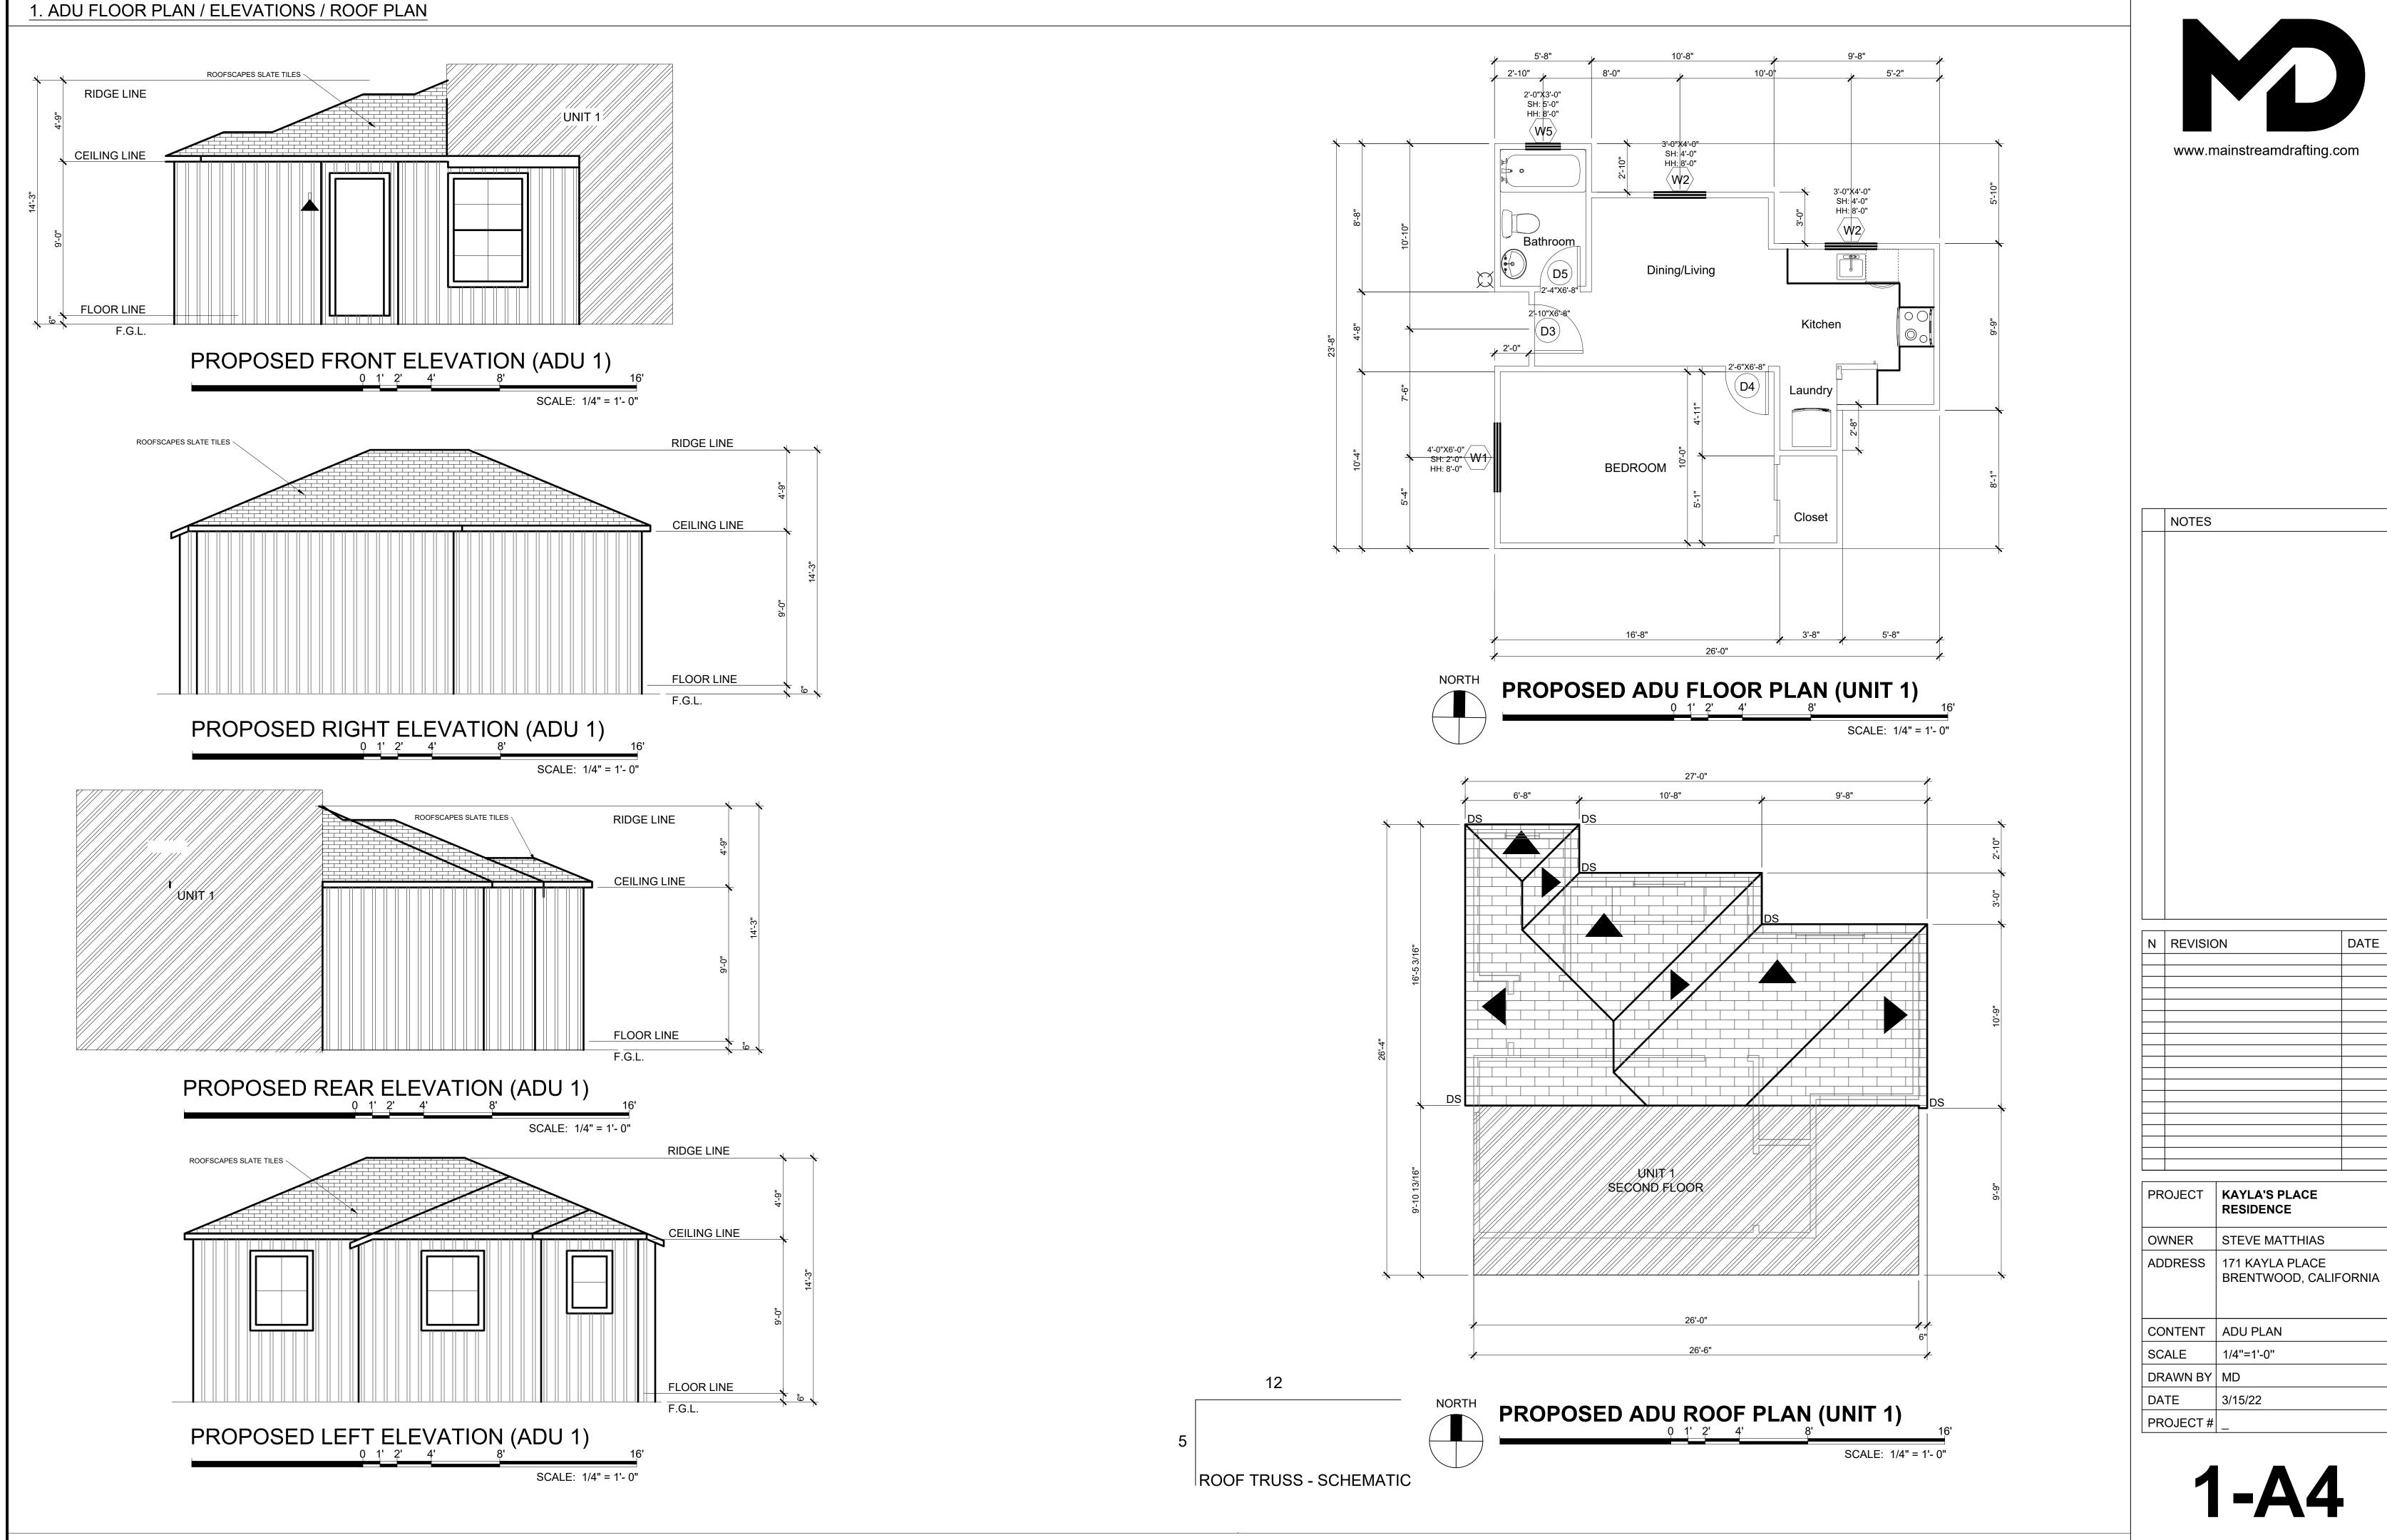
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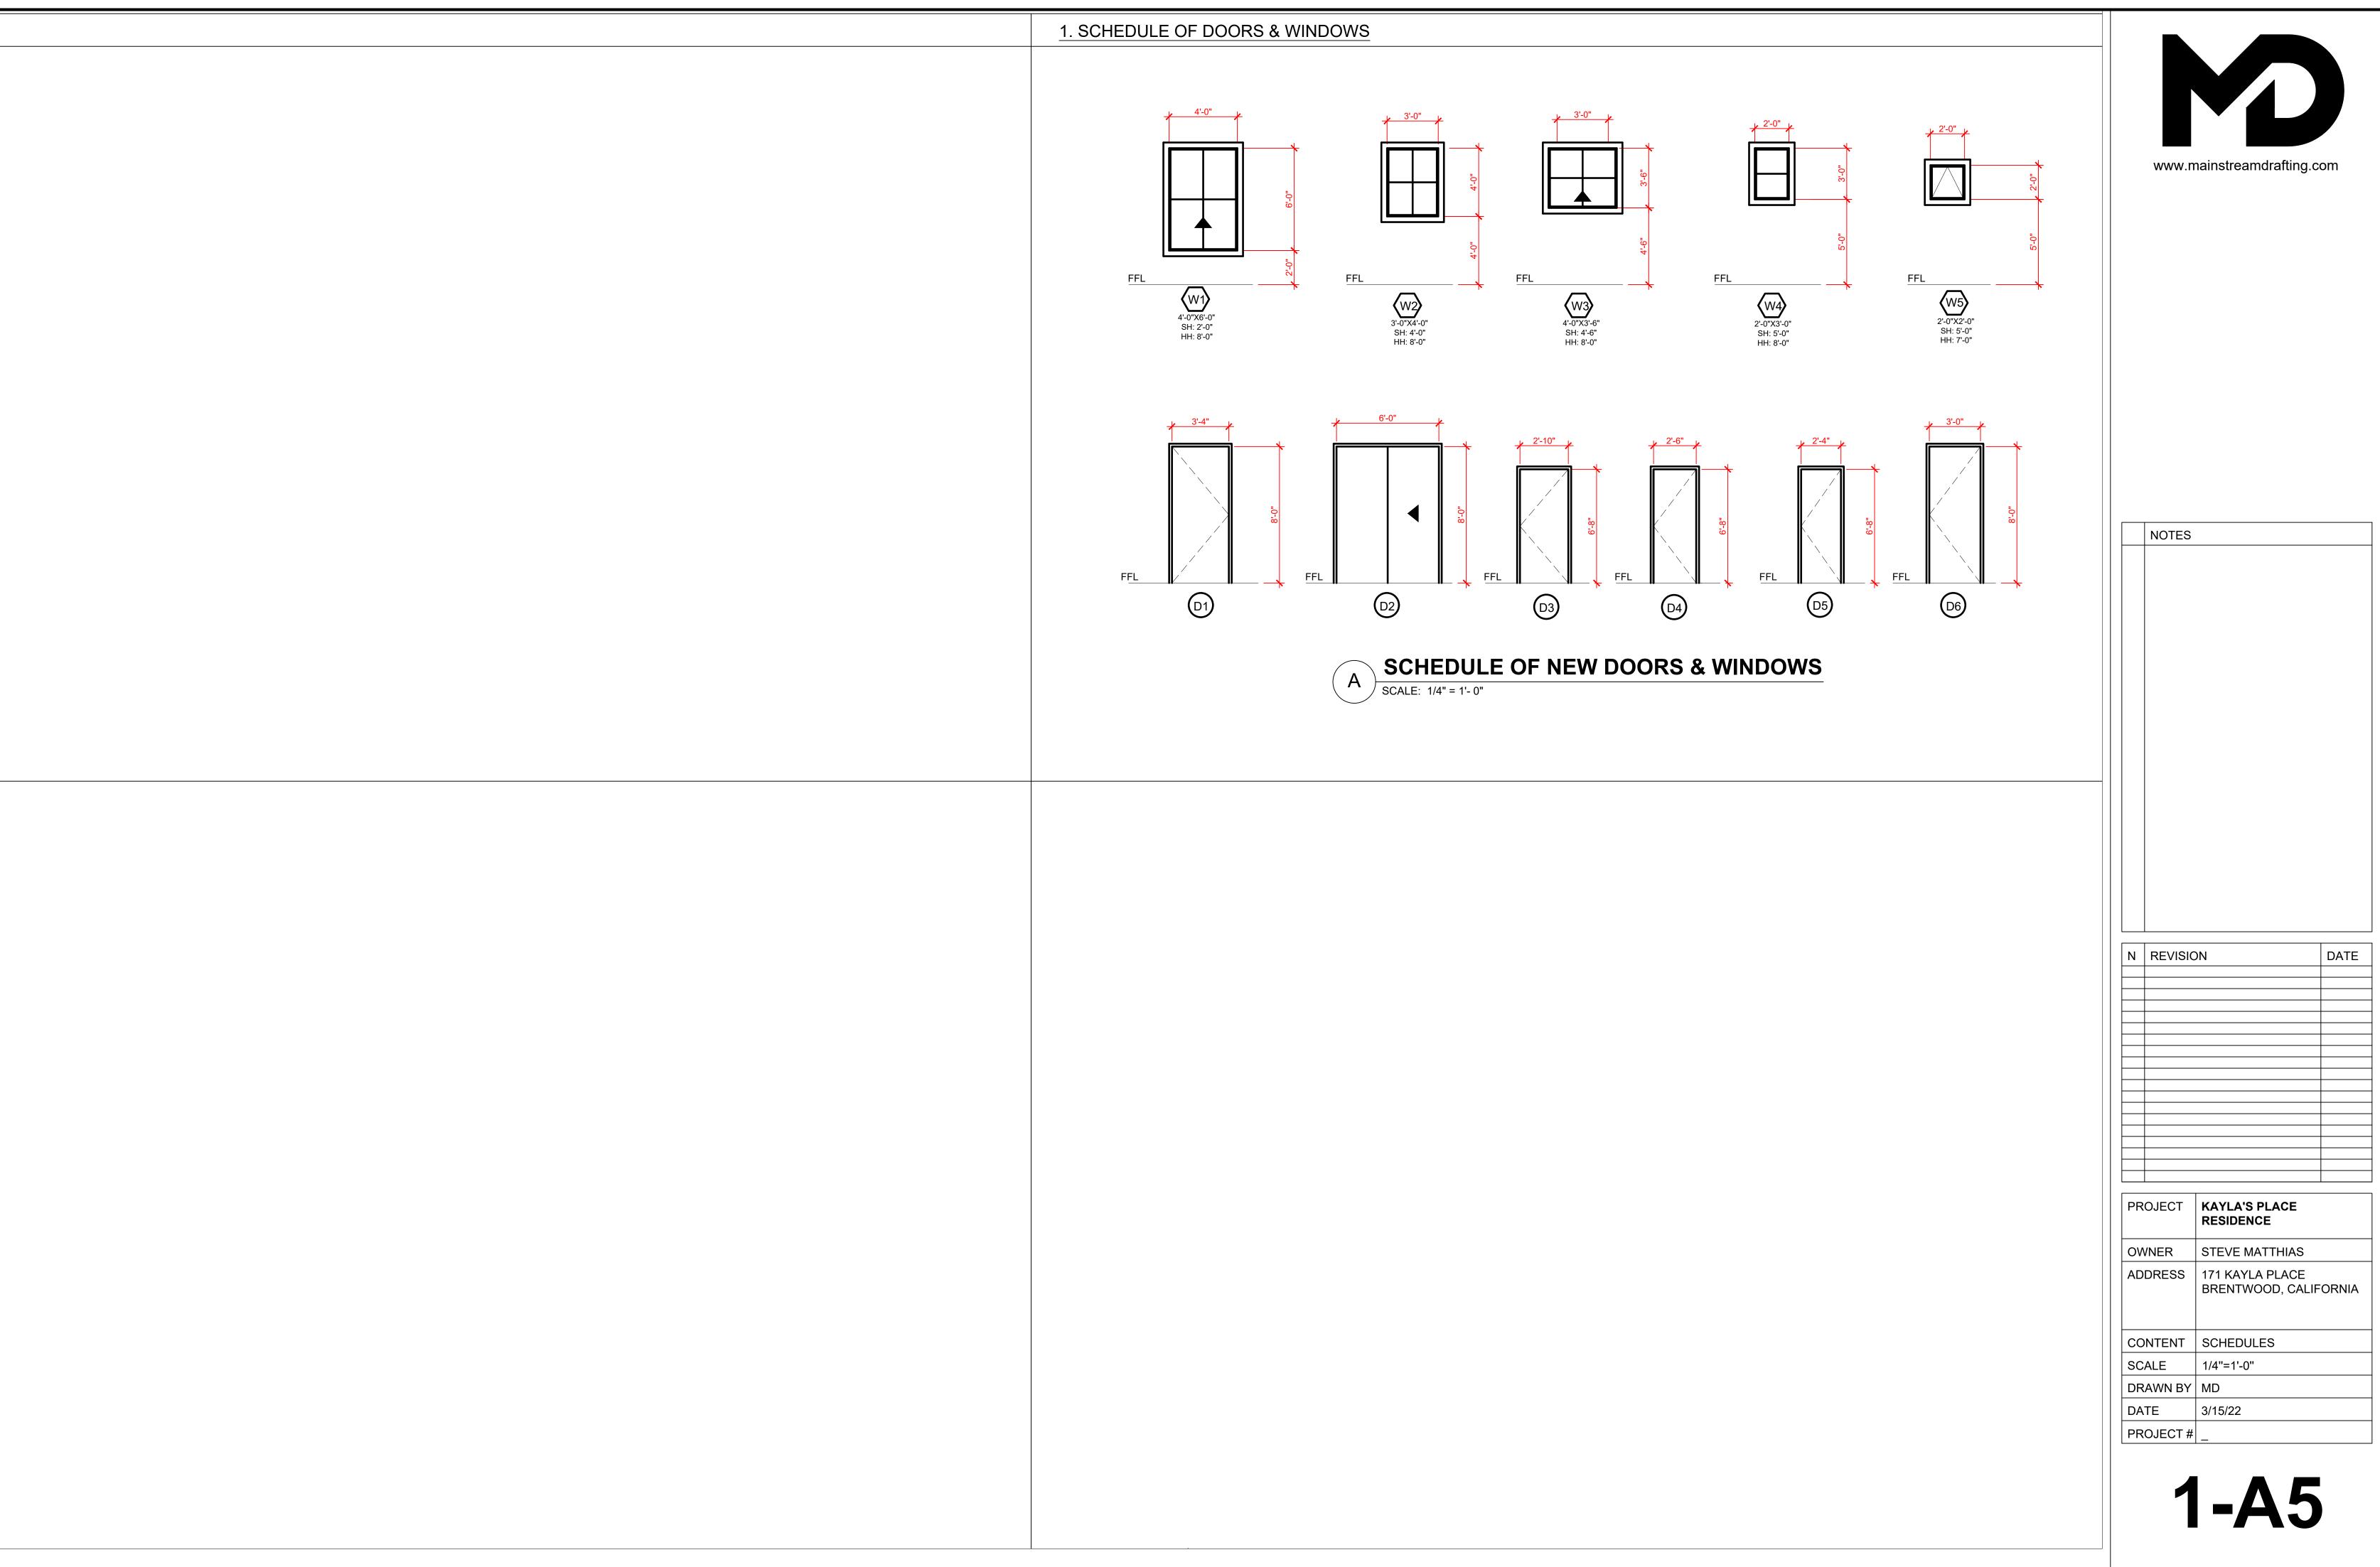


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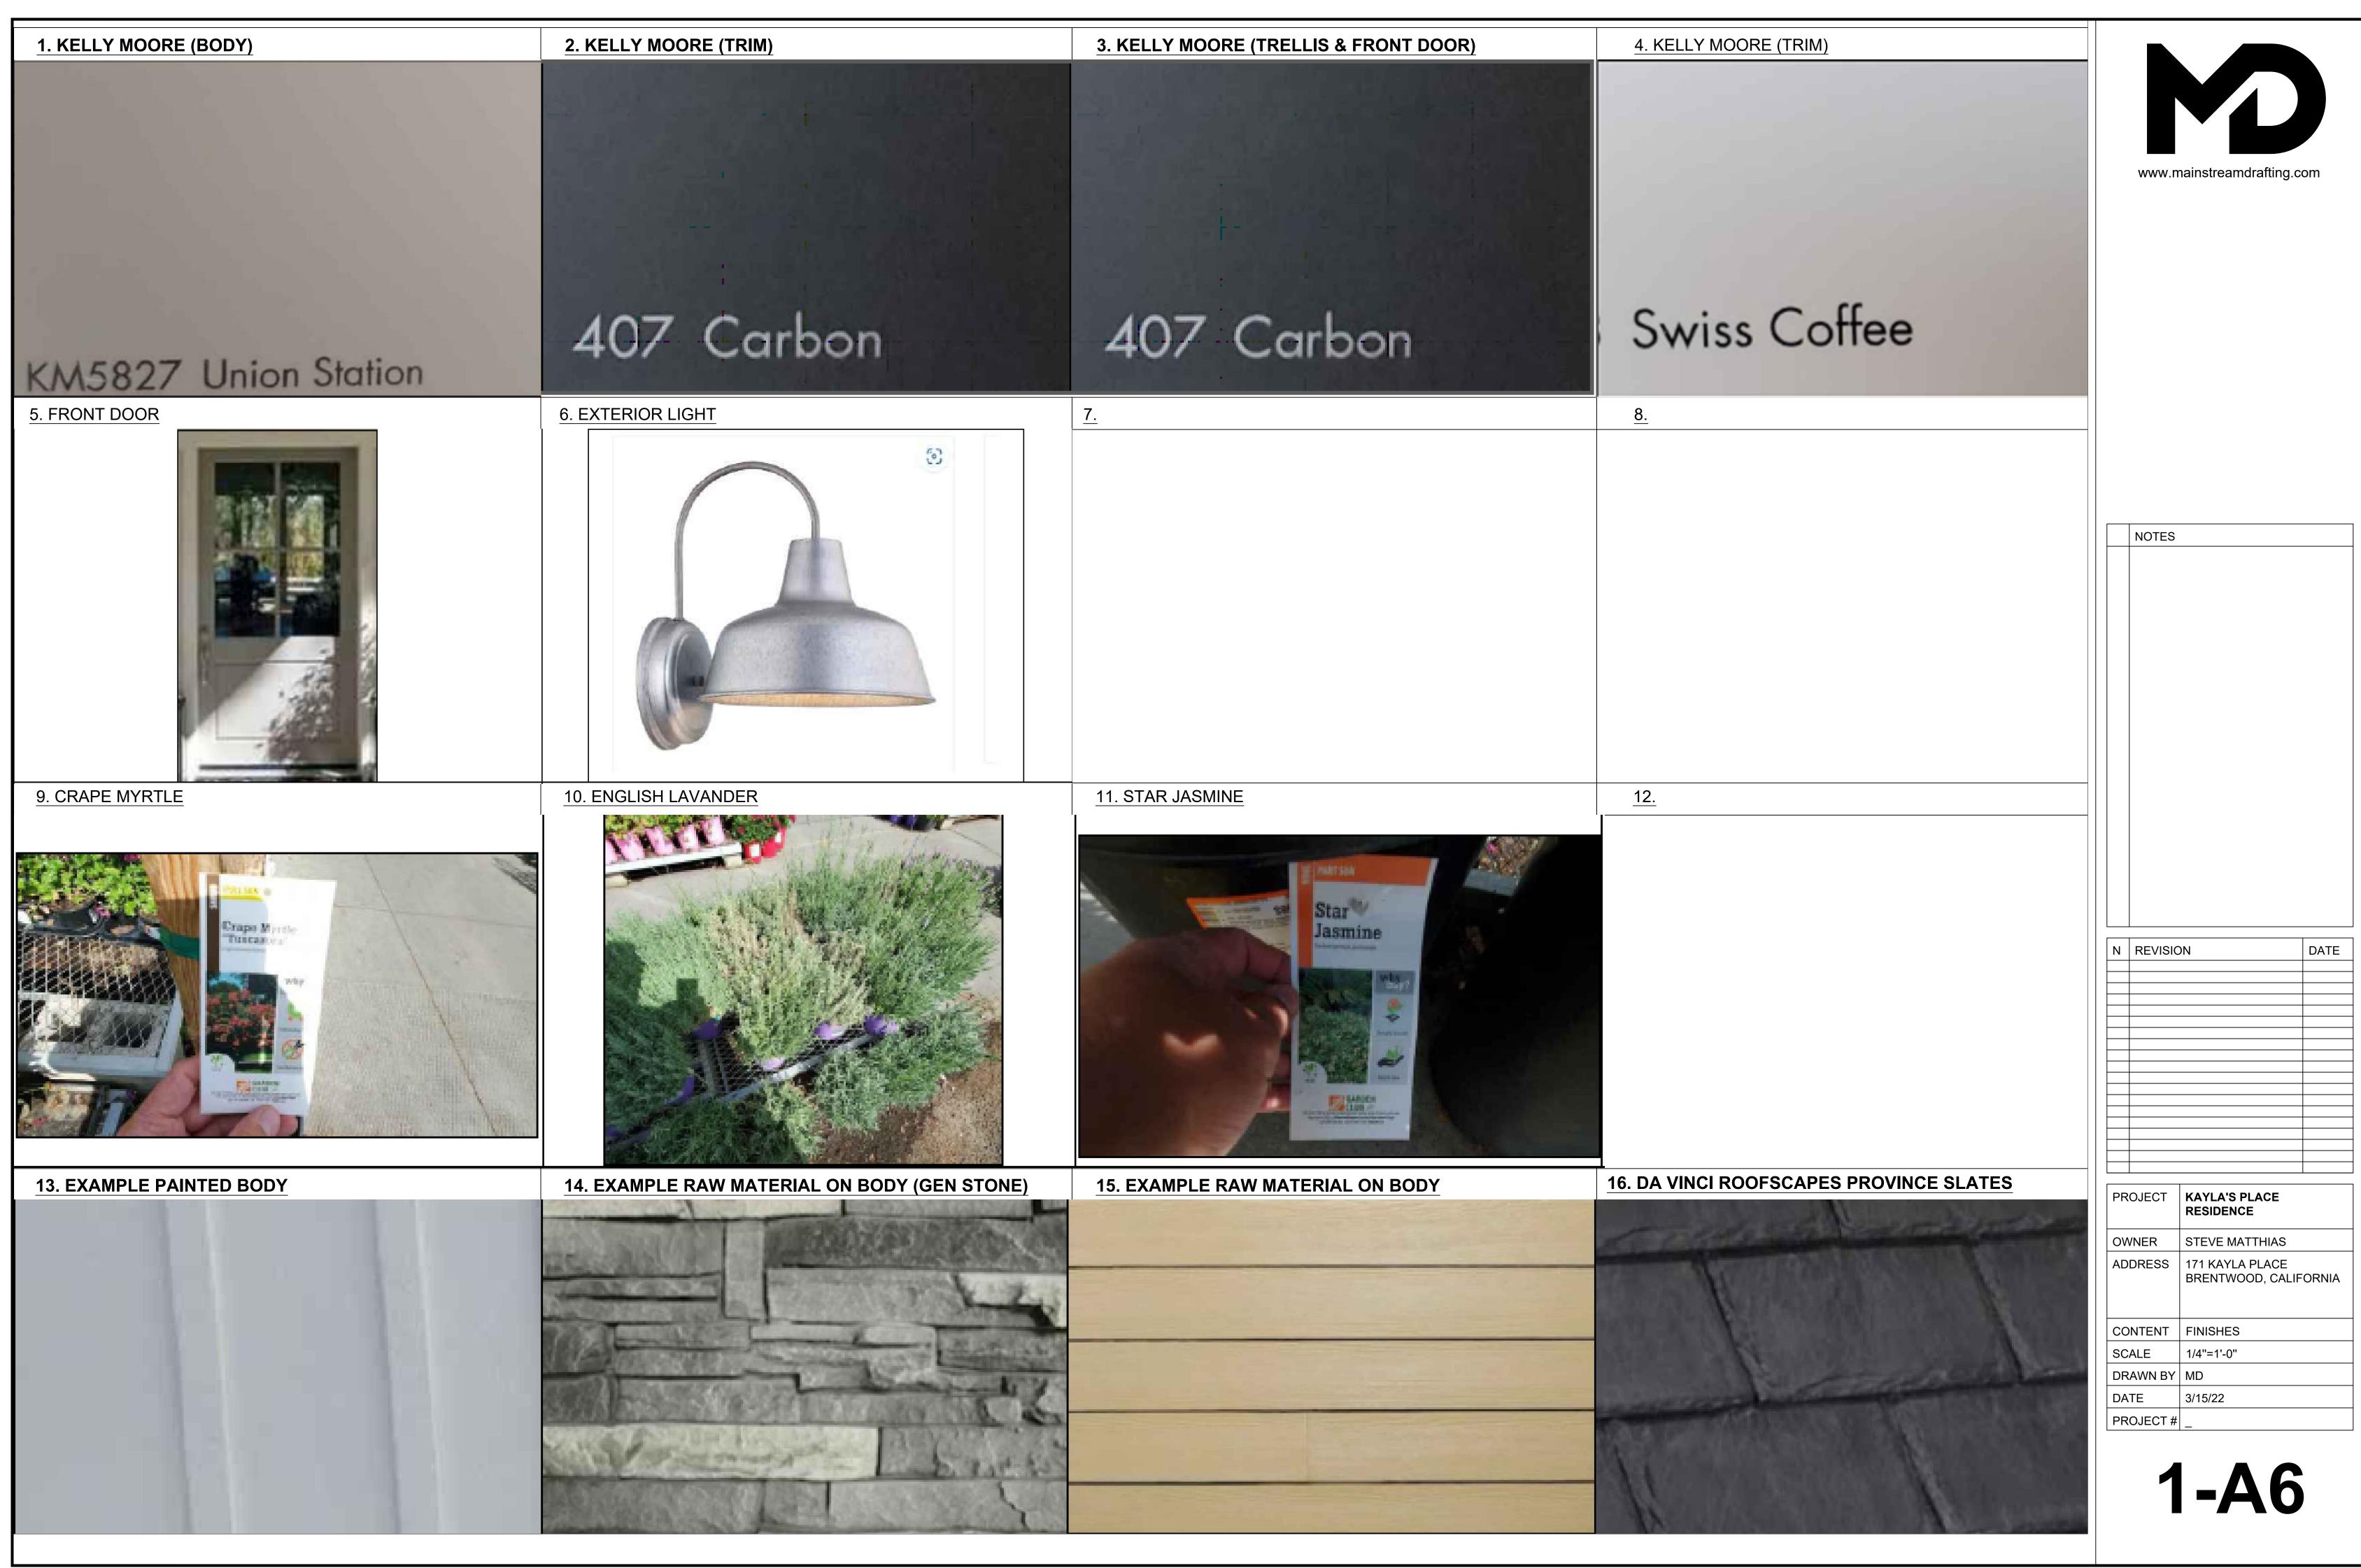

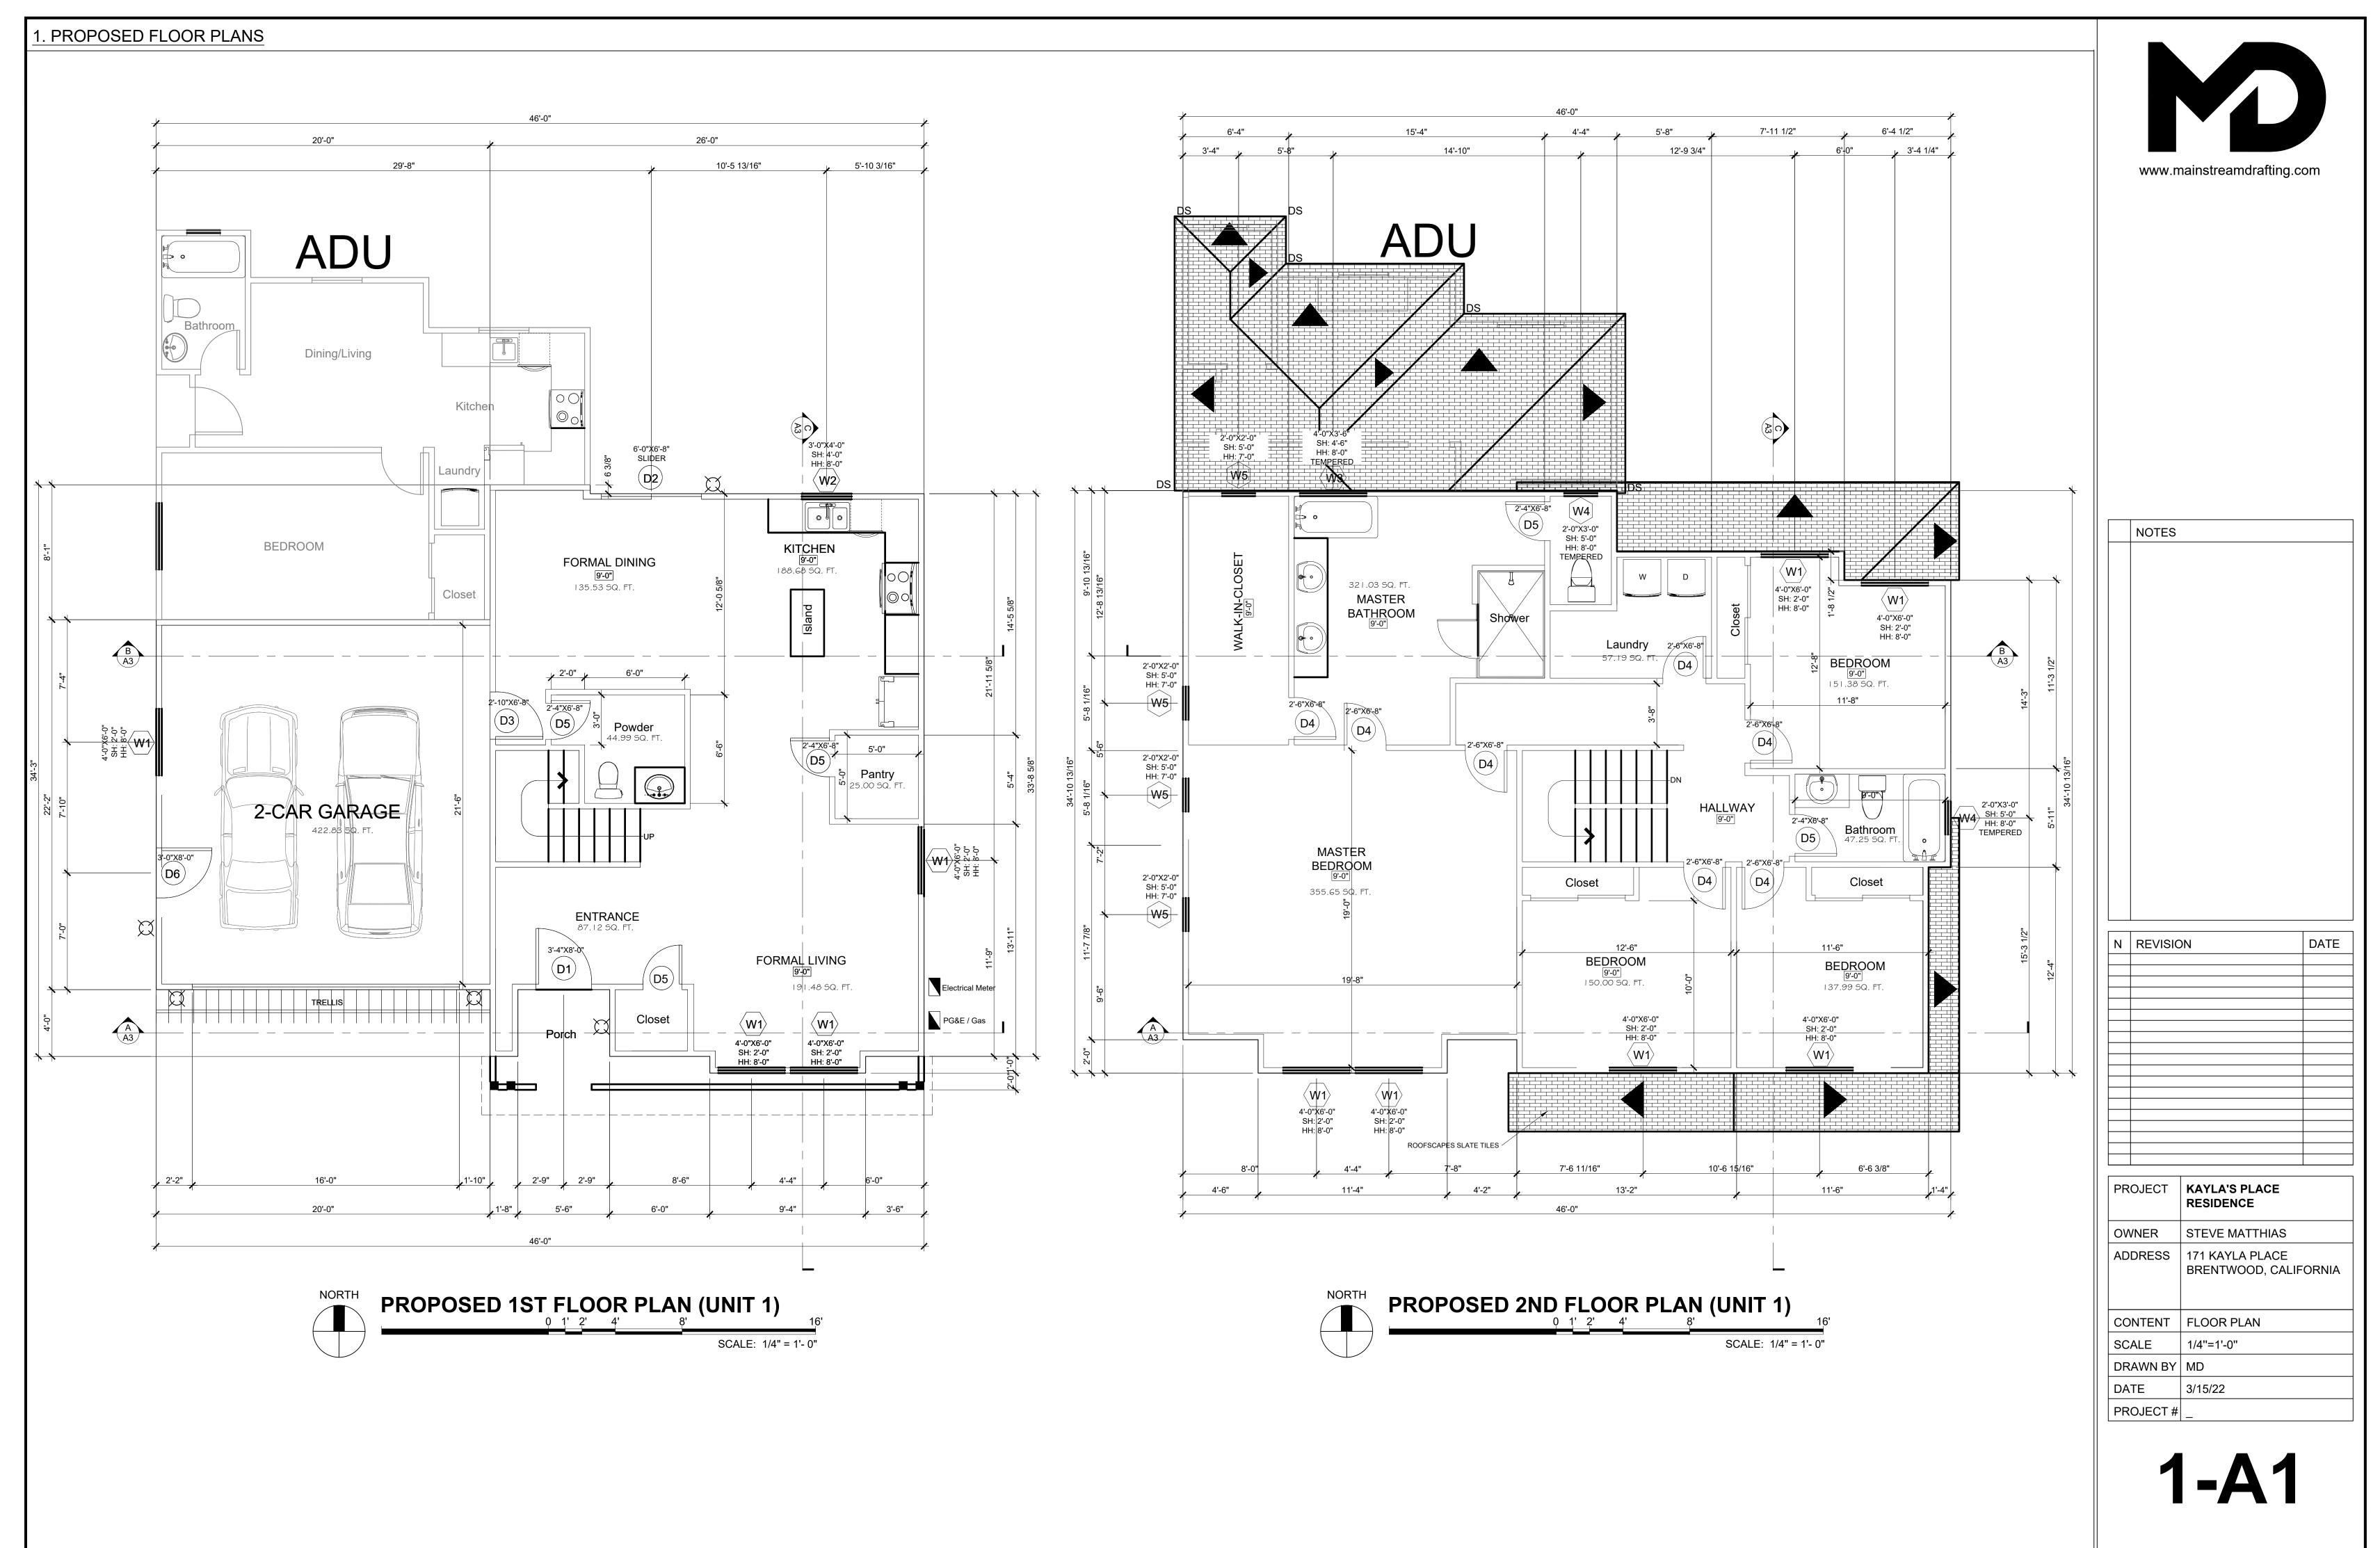
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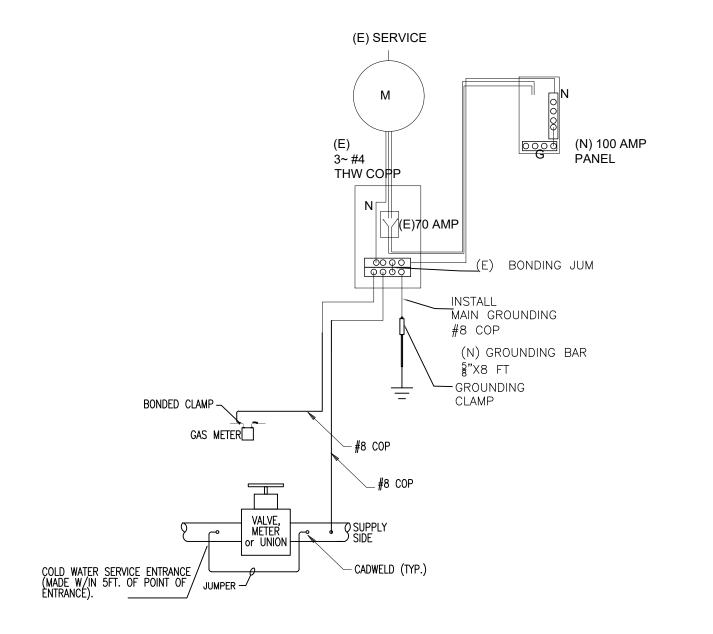
PRINT SIZE: ARCH D 24"X36"



- 1) Manual-on/automatic-off occupant censors, motion censors, photo control astronomical time clock controls, and dimmers installed to comply with Sec150.0(k) and shall be certified to the Energy Commission by their manufacturer, pursuant to the provisions of the Title 20 Appliance Efficiency Regulations, as required by Sec110.9.
- 2) All permanently installed luminaries shall have readily accessible controls that permit the luminaries to be manually switched on and off.
- 3) All lighting controls and equipment shall be installed in accordance with the manufacturer's
- 4) All lighting shall be switched separately from exhaust fans.
- 5) No controls shall bypass the dimmer or vacancy sensor function. The dimmer or vacancy sensor shall be certified to the Energy Commission that it complies with the applicable requirements of
- 6) All added/replaced receptacles shall be listed tamper-resistant receptacles and shall be arc fault
- 7) All installed luminaries shall be high efficiency.
- 8) Under cabinet lighting shall be switched separately from the other lighting system.
- 9) Luminaries recessed into insulated ceilings: (a) shall be listed for zero clearance insulation cover (IC rated); (b) shall include a label certifying air tight (AT) with air leakage less than 2.0 CFM at 75 pascals; (c) shall be sealed with a gasket or caulk between the luminary housing and ceiling; (d) if recessed lights are equipped with ballasts, shall allow ballast maintenance and replacement without requiring cutting of holes in the ceiling; and (e) shall not contain screw base sockets.
- 10) Dwellings are to be equipped with smoke alarms installed in the following locations:
 - a) In each existing sleeping room.
 - b) Outside each separate sleeping area in the immediate vicinity of the bedrooms.
 - c) On each story including basements and habitable attics, not including crawl spaces
 - and uninhabitable attics.
 - d) Installed not less than 3 feet horizontally from the door or opening of a bathroom that contains a bathtub or shower unless this would prevent replacement of a smoke alarm required by CRC.
- 11) Lighting controls maybe either individual devices or systems consisting of two or more components. Lighting control systems and EMCS must meet the requirements of Sec.110.9. 12) All lighting attached to the residence or to other buildings on the same lot must be high efficacy, and must be controlled by a manual ON and OFF switch and on the following automatic control types:
 - 1. Photocontrol and motion sensor.
 - 2. Photocontrol and automatic time switch control
 - 3. Astronomical time clock control that automatically turns the outdoor lighting off during daylight hours.
 - 4. EMCS that provides the functionality of an astronomical time clock, does not have an override of bypass switch that allows the luminaries to be always ON, and is programmed to be automatically turn the outdoor lighting off during daylight hours.

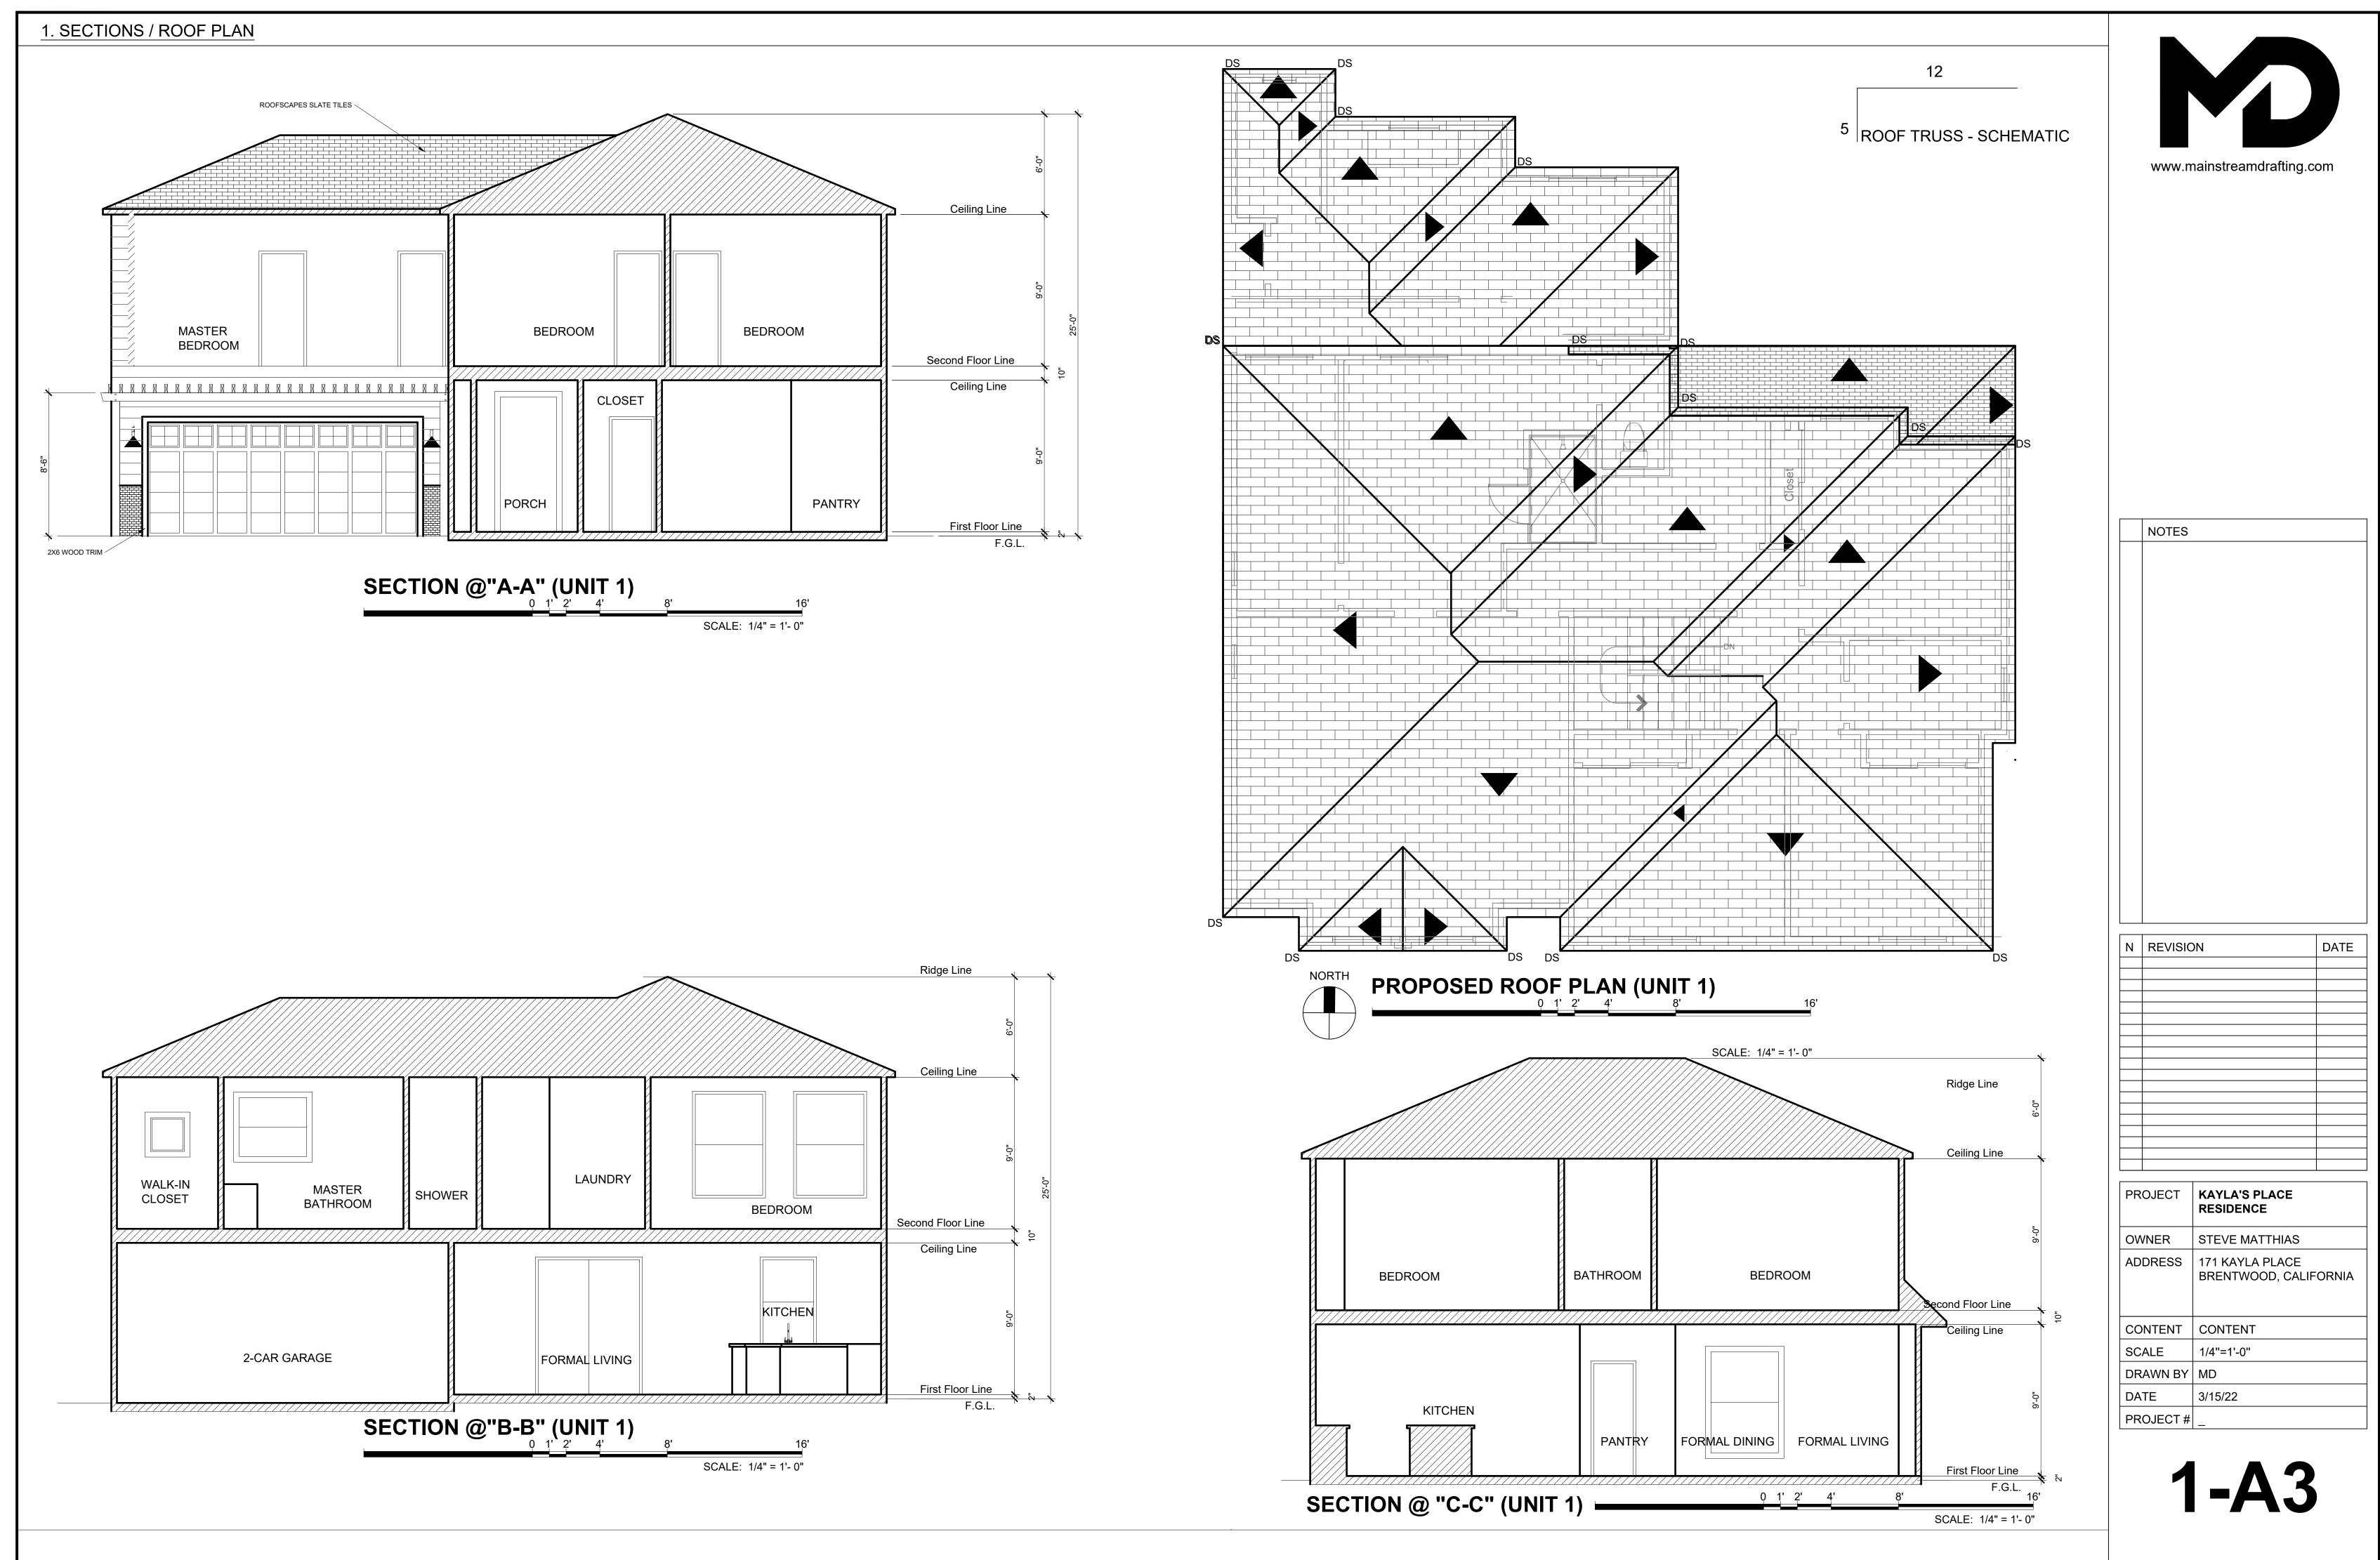Manual ON and OFF switches must not override the automatic control functions listed above, and any control that overrides the automatic controls to ON must automatically reactivate those controls within six hours.

13) Balconies, decks, and porches that are accessible from inside the dwelling unit shall have at least one receptacle outlet installed within the perimeter of the balcony, deck, or porch. The receptacle shall not be located more than 6.5ft above the balcony, deck, or porch surface.



ONE LINE DIAGRAM

N.T.S.

3. ELECTRICAL LEGEND

₩ 110 VOLT DUPLEX OUTLET AFCI

HOSE BIBB

GROUND FAULT CIRCUIT INTERRUPTER 220 VOLT OUTLET RECESSED CAN LIGHT (LED) CEILING MOUNTED OR PENDANT LIGHT FIXTURE (LED) WALL MOUNTED LIGHT FIXTURE (LED) EXHAUST FAN

STRIP LIGHTS ₩ SINGLE POLE SWITCH HS3 3-WAY SWITCH


> ☐ DIMMER SWITCH GARBAGE DISPOSAL

SD SMOKE DETECTOR

C CARBON MONOXIDE DETECTOR SMOKE DETECTOR HARD WIRED

BATTERY BACK UP EMERGENCY LIGHTS ILLUMINATED EXIT SIGNS



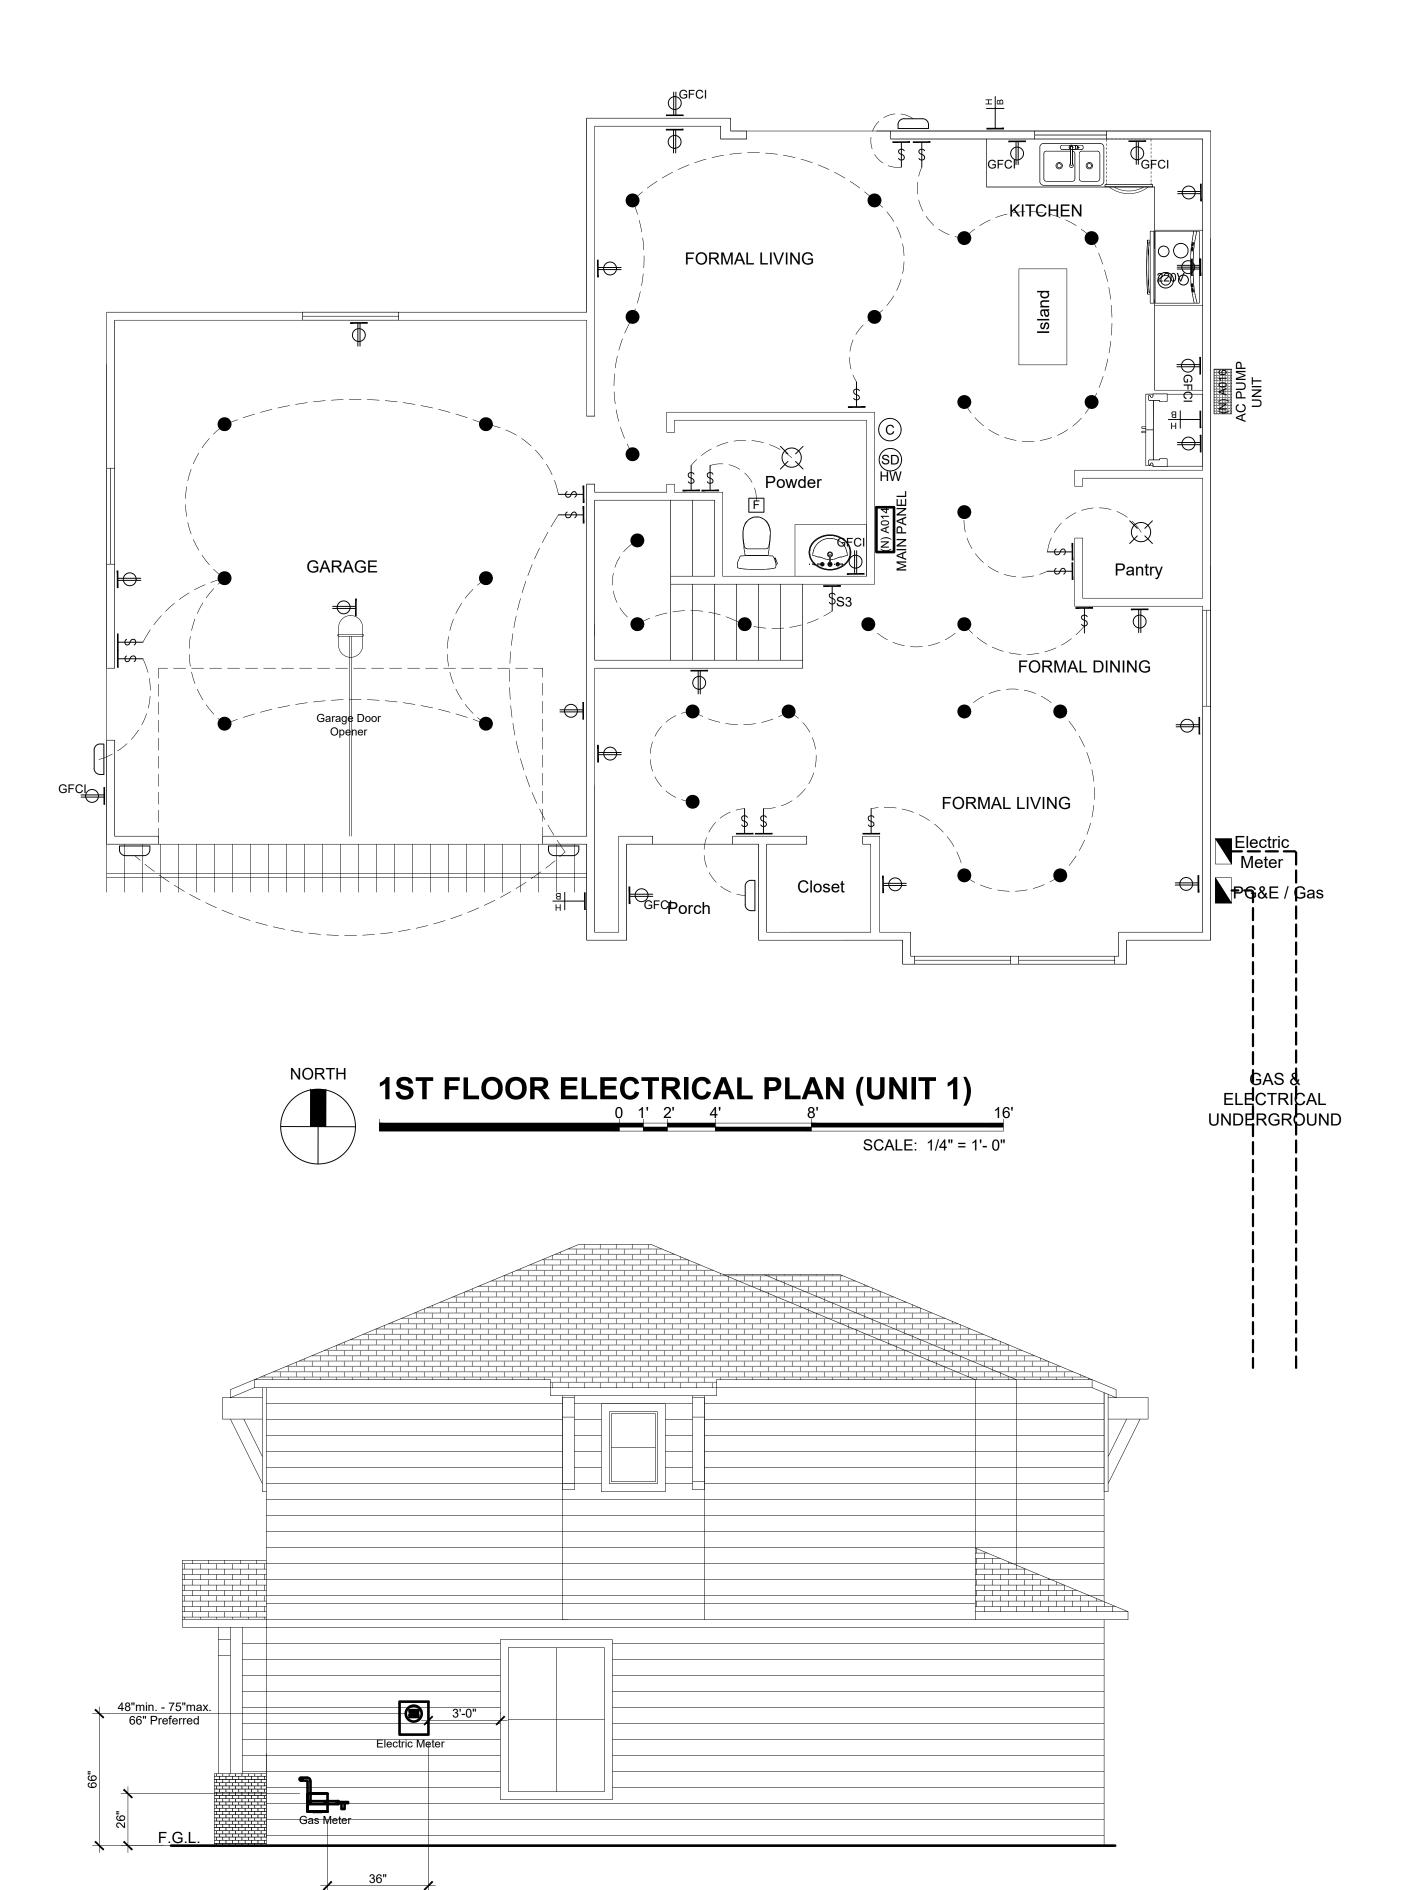



NOTES


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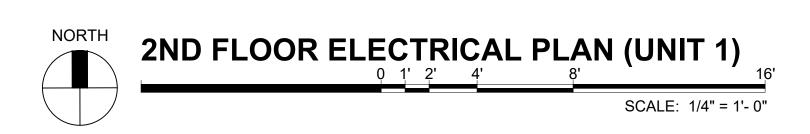
PROJECT	KAYLA'S PLACE RESIDENCE
OWNER	STEVE MATTHIAS
ADDRESS	171 KAYLA PLACE BRENTWOOD, CALIFORNIA
CONTENT	ELECTRICAL PLAN
SCALE	1/4"=1'-0"
DRAWN BY	MD
DATE	3/15/22
PROJECT#	


1-E1

DATE





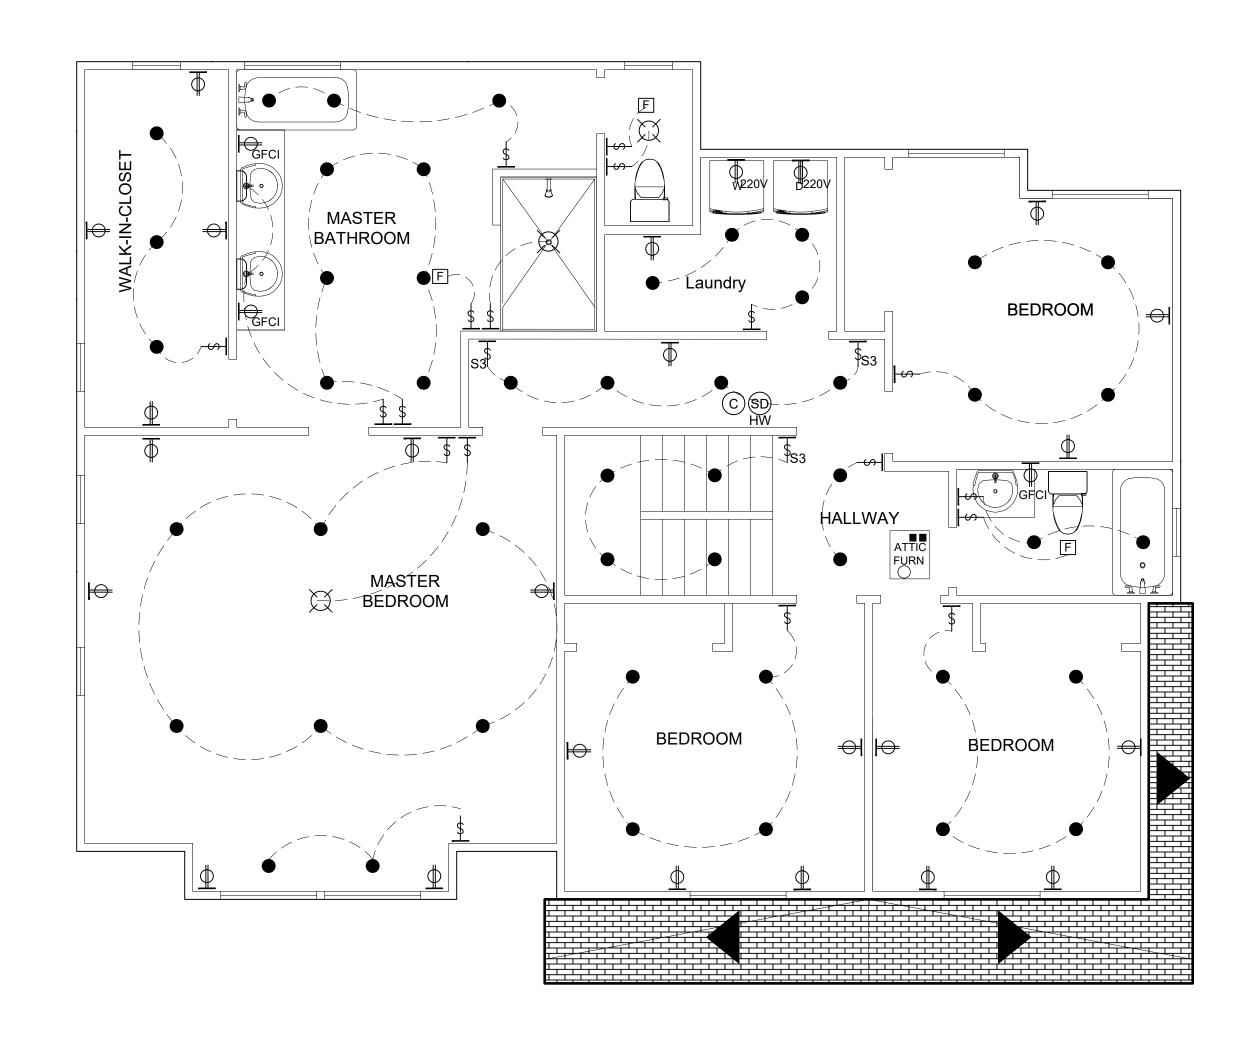

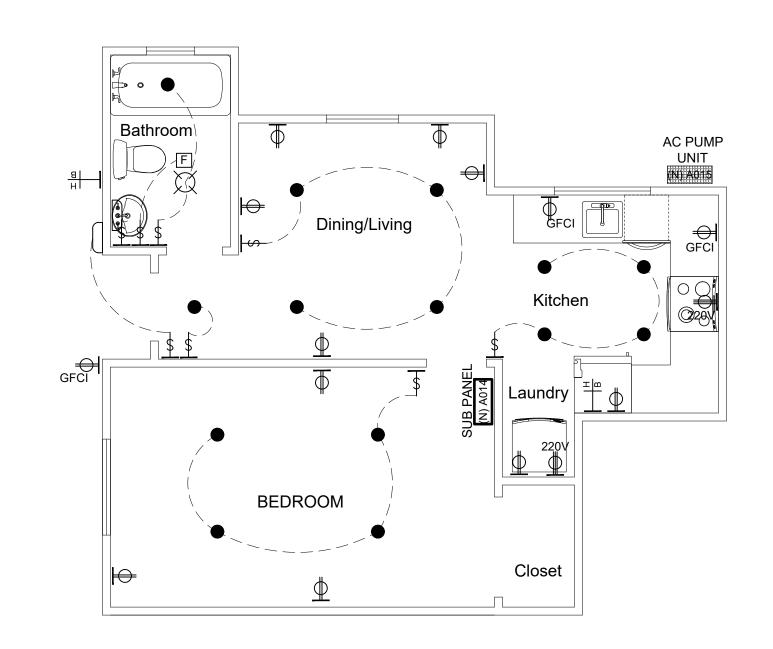



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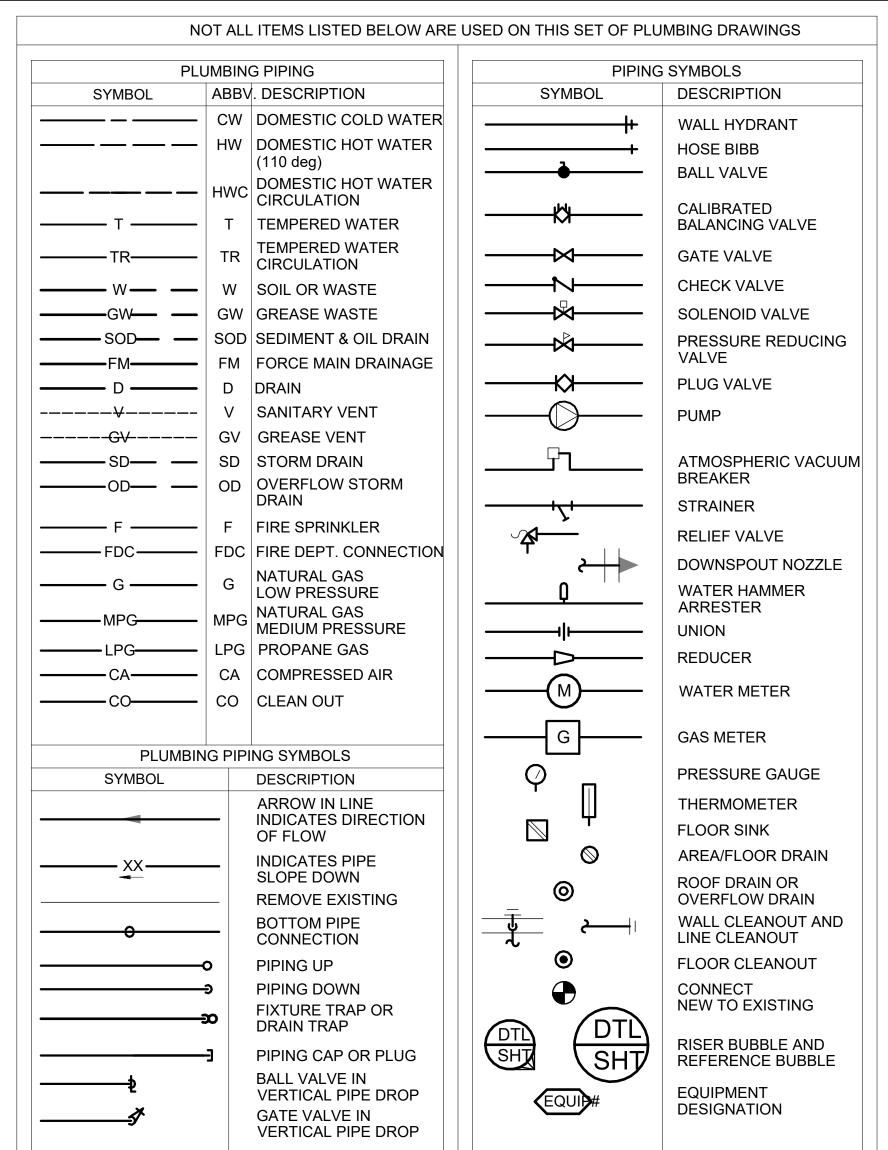
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	OWNER	STEVE MATTHIAS
	ADDRESS	171 KAYLA PLACE BRENTWOOD, CALIFORNIA
	CONTENT	ADU ELECTRICAL PLAN
	SCALE	1/4"=1'-0"
	DRAWN BY	MD
	DATE	3/15/22
	PROJECT#	_

1-E2

2. PLUMBING NOTES

- 1) All work and materials shall meet the requirements of the 2016 California Plumbing and Mechanical Code.
- 2) Gas piping shall be leak tested per code.
- 3) Maximum flow rate for water closets is 1.28 gallons per flush.
- 4) Maximum flow rate for showerheads is 1.8 gallons per minute. For multiple showerheads serving one shower, the combined flow rate of all showerheads and/or other shower outlets controlled by a single valve shall not exceed 1.8 gallons per minute at 80 pounds per square inch, or the shower shall be designed to allow only one shower outlet to be in operation at a time. A handled shower is considered a showerhead.
- 5) Flow rate for lavatory faucets is 1.2 gallons per minute maximum and 0.8 gallons per minute minimum.
- 6) Stub out all services per equipment manufacturer's recommendations.
- Prior to final inspection all non-compliant plumbing fixtures shall be upgraded with water conserving fixtures as required.
- 8) Fans shall be Energy Star compliant and and ducted to terminate outside the
- 9) Bathroom exhaust fan(s) must be controlled by a humidistat which shall be
- 10) A humidity control maybe a separate component to the exhaust fan and is not required to be integral.
- 11) Exhaust fans shall be switched separately from the lighting system.
- 12) Toilet rooms, which are not equipped with a window that provides a ventilation opening of at least 1.5 sq.ft., shall be provided with mechanical ventilation with an exhaust capacity of at least 50 cubic feet per minute.
- 13) Termination of all environmental air ducts (e.g., bath fan dryer vent, etc.) shall be at least 3 feet from a property line and from openings into the building, and 10 feet from the forced air inlet..
- 14) Dryer moisture exhaust duct shall terminate to the outside and shall be equipped with a back-draft damper. Exhaust duct length is limited to a combined horizontal and vertical length of 14 feet with 2 elbows. Two feet shall be deducted for each 90 degree elbow in excess of two.
- 15) Shower and tub-shower combinations shall be provided with individual control valves of the pressure balance, thermostatic, or combination pressure balance/ thermostatic mixing valve type that provide scald and thermal shock protection for the rated flow rate of the installed showerhead.

3. PLUMBING LEGEND



REPLACE NON-COMPLIANT PLUMBING FIXTURES
WITH WATER-CONSERVING PLUMBING FIXTUE

1. PLUMBING PLAN

NONE COMPLIANT PLUMBING FIXTURE

1- ANY TOILET MANUFACTURED TO USE MORE THAN 1.6 GPF

2- ANY SHOWERHEAD MANUFACTURED TO HAVE A FLOW CAPACITY OF MORE THAN 2.5 GPM

3- ANY INTERIOR FAUCET THAT EMITS MORE THAN 2.2 GPM

NEW PLUMBING FIXTURE MAXIMUM FLOW RATE

1- WATER CLOSET: < OR EQUAL TO 1.28 G/F

2- SINGLE SHOWERHEAD < OR EQUAL TO 2.0 GPM @ 80 PSI

3- COMMERCIAL LAVATORY FAUCETS < OR EQUAL TO 0.5 GPM

4- KITCHEN FAUCETW < OR EQUAL TO 1.8 GPM @ 60 PSI


PIPE AND FITTING MATERIAL


TYPE	DESCRIPTION
PORTABLE WATER (CW AND HW) IN BUILDING	SCHEDULE 40 GALV. STEEL PIPE OR TYPE L HARD COPPER TUBING
PORTABLE WATER UNDERGROUND WHITHIN 6' OF BUILDING	SCHEDULE 40 GALV. STEEL PIPE OR TYPE K HARD COPPER TUBING
PORTABLE WATER UNDERGROUND 6' BEYOND BUILDING	SCHEDULE 40 GALV. STEEL PIPE OR PVC STANDARD SCHEDULE 40
SANITARY DRAIN PIPING ABOVE GROUND IN BUILDING	HUB AND PLAIN END CAST IRON W/ GASKE
SANITARY DRAIN AND VENT PIPING UNDERGROUND WITHIN 6' OF BUILDING	HUB AND PLAIN END CAST IRON W/ GASKE
SANITARY VENT PIPING ABOVE GROUND IN BUILDING	HUB AND PLAIN END CAST IRON W/ GASKE
SANITARY DRAIN PIPE 6' BEYOND THE BUILDING	PVC GRAVITY SEWER PIPE
NATURAL GAS ABOVE GROUND	SCHEDULE 40 BLACK STEEL PIPE
NATURAL GAS UNDER GROUND	SCHEDULE 40 BLACK STEEL PIPE
EQUIPMENT DRAIN AND RELIEF VALVA DISCHARGE	SCHEDULE 40 GALV. STEEL PIPE OR
RIGID DUCTWORK	GALVANIZED STEEL SHEET METAL
FLEXABLE DUCTWORK	UL 181, CLASS 1 AIR DUCT

	FIXTUI	RE SCHE	DULE	
LABEL	DESCRIPTION	QTY	INFO	STATUS
(N) A01	DISHWASHER	2	PLUMBING: H,C,W	NEW
(N) A02	DOUBLE SINK	1	PLUMBING: H,C,W	NEW
(N) A03	DRYER	2	ELECTRIC	NEW
(N) A04	FRIDGE	2	PLUMBING: C	NEW
(N) A05	ELECTRIC STOVE	1	PLUMBING: G 40,000 BTU	NEW
(N) A06	SHOWER	1	PLUMBING: H,C,W,T	NEW
(N) A07	SINK	6	PLUMBING: H,C,W	NEW
(N) A08	TOILET	4	PLUMBING: C.W.	NEW
(N) A09	WASHER	2	PLUMBING: H.C.W	NEW
(N) A010	GAS METER	1	PLUMBING: G	NEW
(N) A011	BATH SHOWER COMBO	3	PLUMBING: H,C,W,T	NEW
(N) A012	TANKLESS WATER HEATER	1	PLUMBING: C ELECTRIC	NEW
(N) A013	ELECTRICAL METER	1		NEW
(N) A014	MAIN PANEL	2	200 AMP	NEW
(N) A015	DUCTLESS MINI SPLIT	1	ELECTRIC, SEER AND EER PER T24	NEW
(N) A016	AC PUMP UNIT	1	ELECTRIC, PER T24	NEW
(N) A017	ELECTRIC STOVE	1	PLUMBING: G 40,000 BTU	NEW


REQUIRED GAS PIPING SIZE

			GAS					NATURAL			
					INLET PRESSURE			LESS THAN 2 psi			
PRESSURE DROP						0.5 in. w.c.					
					SPECIFIC GRAVITY			0.60			
	PIPE SIZE (inch)										
NOMINAL:	1/2	<u>3</u> 4	1	1 ½	1 ½	2	2 ½	3	4	5	
ACTUAL ID:	0.622	0.824	1.049	1.380	1.610	2.067	2.469	3.068	4.026	5.047	
LENGTH (feet)		CAPACITY IN CUBIC FEET OF GAS PER HOUR									
10	172	360	678	1390	2090	4020	6400	11 300	23 100	41 800	
20	118	247	466	957	1430	2760	4400	7780	15 900	28 700	
30	95	199	374	768	1150	2220	3530	6250	12 700	23 000	
40	81	170	320	657	985	1900	3020	5350	10 900	19 700	
50	72	151	284	583	873	1680	2680	4740	9660	17 500	
60	65	137	257	528	791	1520	2430	4290	8760	15 800	
70	60	126	237	486	728	1400	2230	3950	8050	14 600	
80	56	117	220	452	677	1300	2080	3670	7490	13 600	
90	52	110	207	424	635	1220	1950	3450	7030	12 700	

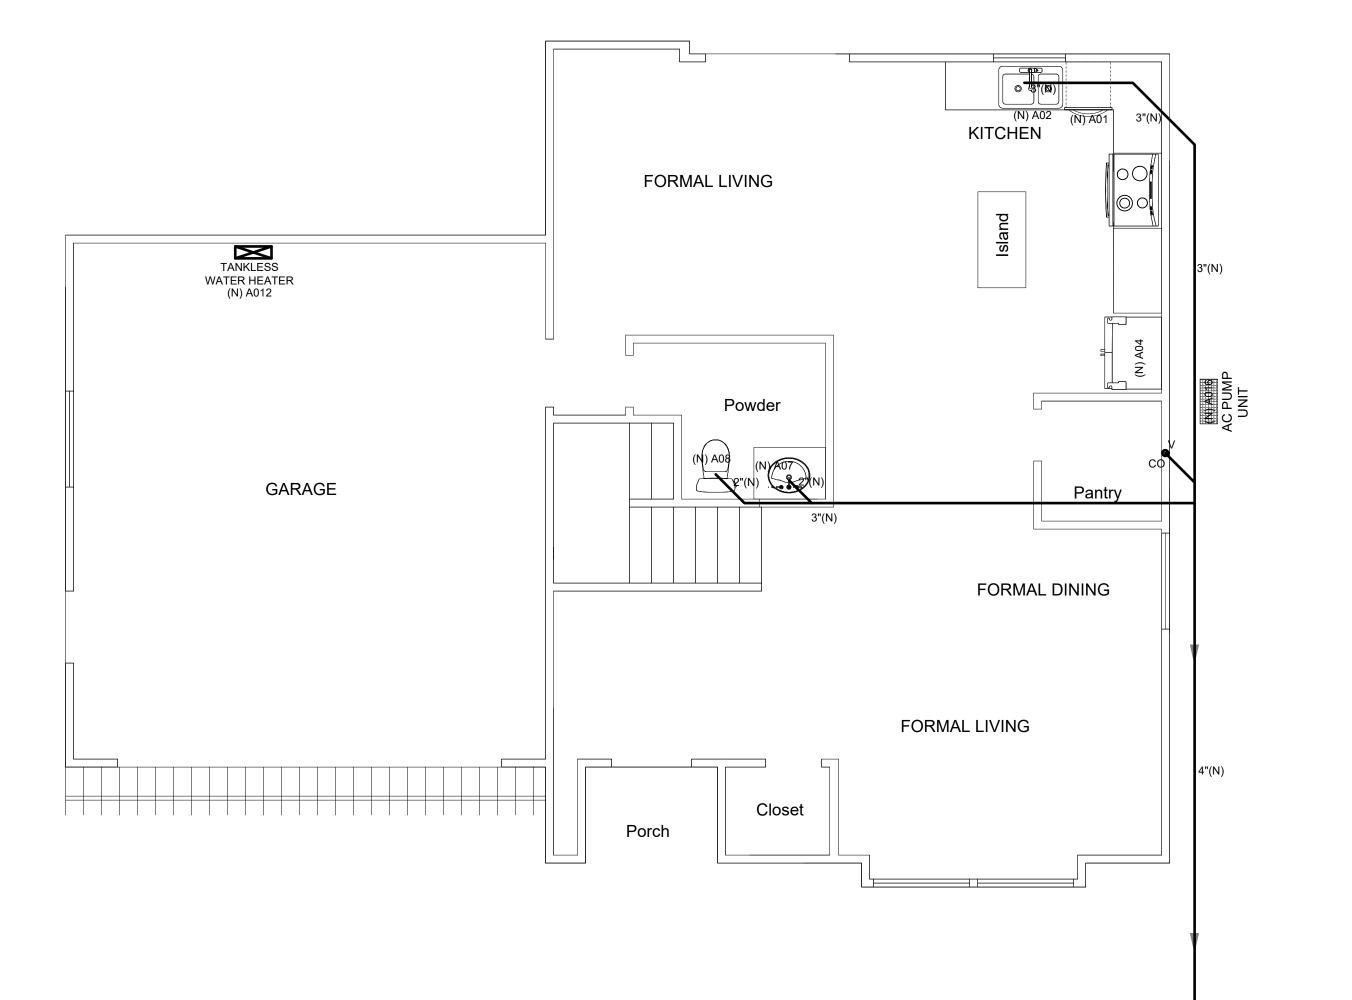

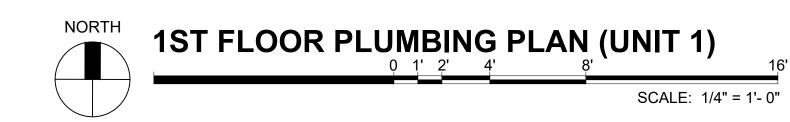



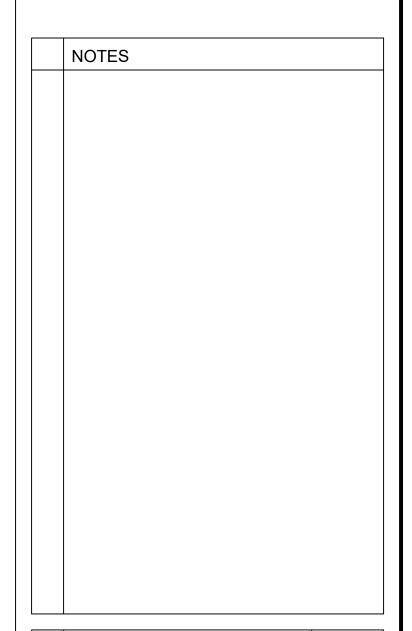

l l		KAYLA'S PLACE RESIDENCE	


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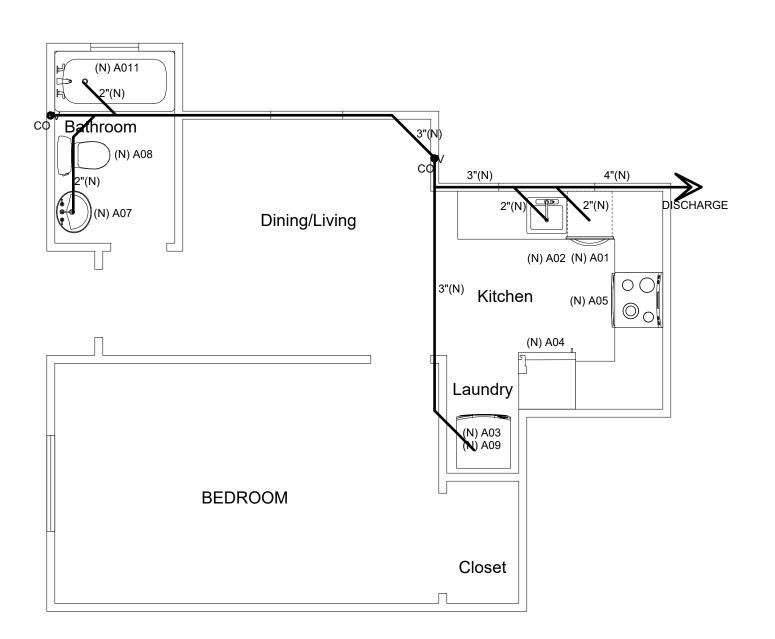
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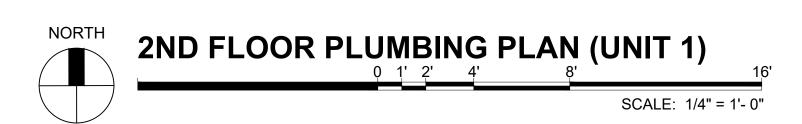
DATE


PROJECT	KAYLA'S PLACE RESIDENCE
OWNER	STEVE MATTHIAS
ADDRESS	171 KAYLA PLACE BRENTWOOD, CALIFORNIA
CONTENT	PLUMBING PLAN
SCALE	1/4"=1'-0"
DRAWN BY	MD
DATE	3/15/22
PROJECT#	_

1-P1





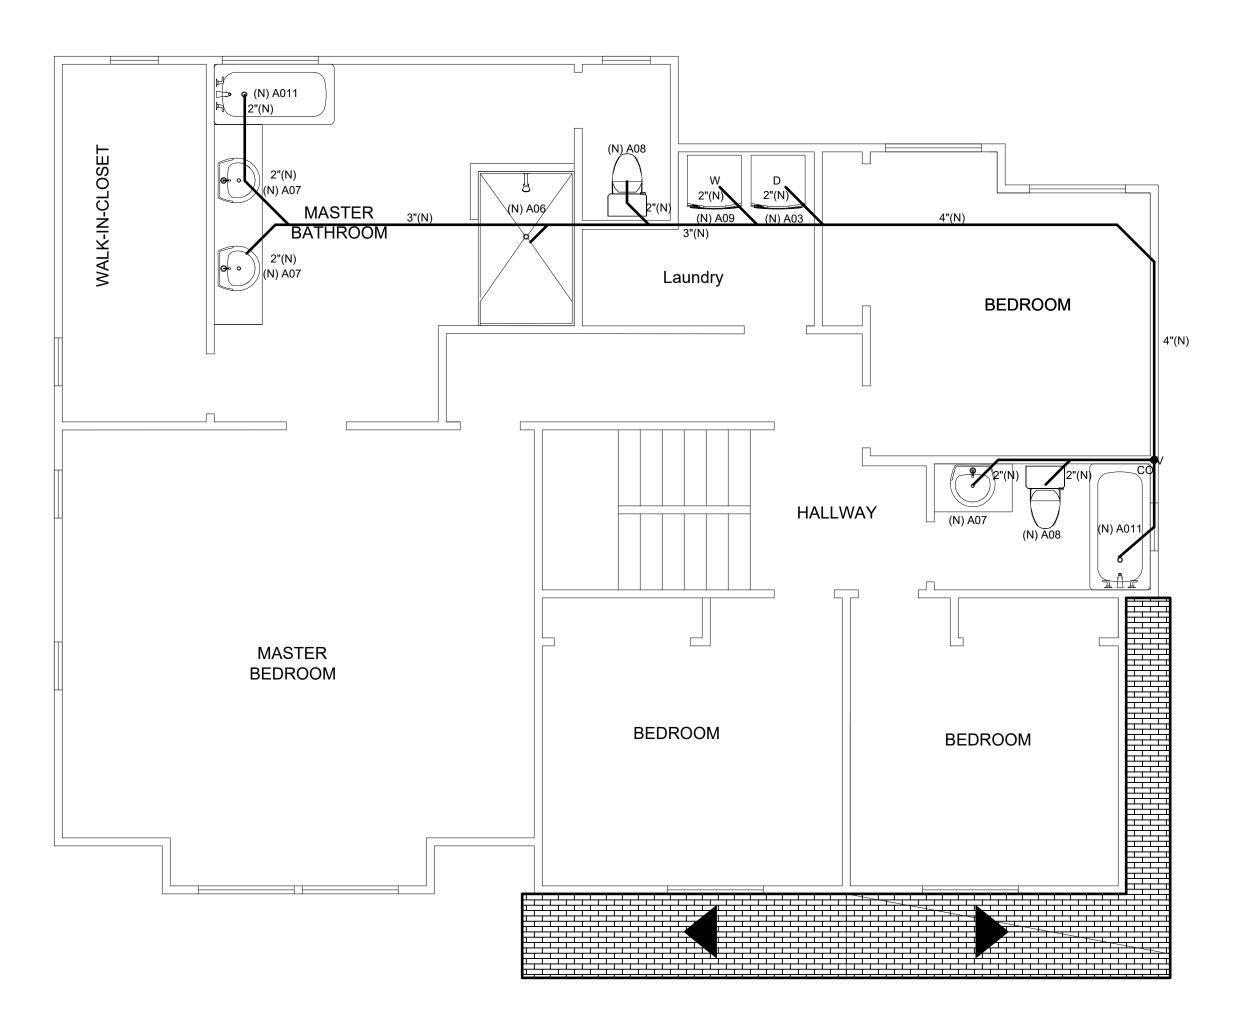

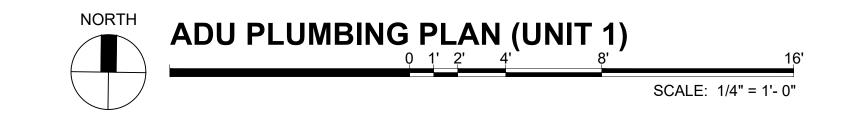



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	REVISIO	REVISION

PROJECT	KAYLA'S PLACE RESIDENCE
OWNER	STEVE MATTHIAS
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CONTENT	PLUMBING PLAN
SCALE	1/4"=1'-0"
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1-P2

FIXTURE SCHEDULE				
LABEL	DESCRIPTION	QTY	INFO	STATUS
(N) A01	DISHWASHER	2	PLUMBING: H,C,W	NEW
(N) A02	DOUBLE SINK	1	PLUMBING: H,C,W	NEW
(N) A03	DRYER	2	ELECTRIC	NEW
(N) A04	FRIDGE	2	PLUMBING: C	NEW
(N) A05	ELECTRIC STOVE	1	PLUMBING: G 40,000 BTU	NEW
(N) A06	SHOWER	1	PLUMBING: H,C,W,T	NEW
(N) A07	SINK	6	PLUMBING: H,C,W	NEW
(N) A08	TOILET	4	PLUMBING: C.W.	NEW
(N) A09	WASHER	2	PLUMBING: H.C.W	NEW
(N) A010	GAS METER	1	PLUMBING: G	NEW
(N) A011	BATH SHOWER COMBO	3	PLUMBING: H,C,W,T	NEW
(N) A012	TANKLESS WATER HEATER	1	PLUMBING: C ELECTRIC	NEW
(N) A013	ELECTRICAL METER	1		NEW
(N) A014	MAIN PANEL	2	200 AMP	NEW
(N) A015	DUCTLESS MINI SPLIT	1	ELECTRIC, SEER AND EER PER T24	NEW
(N) A016	AC PUMP UNIT	1	ELECTRIC, PER T24	NEW
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