# C'est La Vie

RECEIVED

August 12, 2024

CITY OF BRENTWOOD **COMMUNITY DEVELOPMENT DEPT** 

## LANDLORD TENANT IMPROVEMENT IN BRENTWOOD, CA

#### **ABBREVIATIONS**

**ABOVE** MAXIMUM ACCESSIBLE/ ACCESSIBILITY MANUFACTURE ADD'N. ADDITION MINIMUM A.F.F. ABOVE FINISHED FLOOR MOUNTED METAL NEW BOARDS NOT IN CONTRACT BLOCKING O/C O.C. ON CENTER CABINET OCCUPANT/ OCCUPANCY C.B.C. CALIFORNIA BUILDING CODE C.P.C. CALIFORNIA PLUMBING CODE OPENING CHAP.CHAPTER OPERATED CEILING JOINT OPPOSITE CLOSET PT./ PART. PARTIAL CNTR COUNTER PLYWD. PLYWOOD CLEAN-OUT CONTINUOUS P.O.S. POINT OF SCALE CERAMIC TILE PRESS PRESSURE DEG. DN. DEGREE P.R.V. PRESSURE RELIEF VALVE DOWN P.S.I. POUNDS PER SQUARE INCH DOUBLE P.S.F. POUNDS PER SQUARE FOOT DOWN SPOUT PRESSURE TREATED DIAMETER RELOCATED DECK JOINT RADIUS, RISER EXISTING RETURN AIR ELECTRIC ELEV.L. ELEVATION REINFORCED **ENCLOSURE** REQUIRED/ REQUIREMENT EXTERIOR ROUGH SWAN ROUGH OPENING FAU. FORCED AIR UNIT SUPPLY AIR FIBERGLASS S.A.B. SOUND ATTENUATION BATTS FLOOR DRAIN SMOKE DETECTOR FOUNDATION SCALE FULL LIGHT STEES SCHEDULE F.S. FLOOR SINK SHOWER FX FIXT SINGLE HUNG FIXTURE FLOOR JOINT SLIDING, SLIDER SINGLE FLUOR. FLUORESCENT S.O.G. SLAB ON GRADE FRAMING STAINLESS STEEL FIBERGLASS REINFORCED S.S.D. SWW STRUCTURAL DRAWINGS FT. FTG. SHEET VINYL FOOTING TEMPERED FURN.FURNACE/FURNITURE TELEPHONE GAUGE T & G TONGUE & GROOVE GALV. GALVANIZED TRUE DIVIDED LITE GENERAL CONTRACTOR T-24 TITLE 24 ENERGY COMPLIANCE GROUND FAULT INTERRUPT TRASH COMPACTOR T.O.C. TOP OF CURB GLB GLUE LAMINATED BEAM T.O.S. TOP OF SLAB G.S.M.GALVANIZED SHEET METAL GYP. BD. GYPSUM BOARD HEAD TYPICAL HOUR UNDER UNDER CABINET HANGER U.O.N. UNLESS OTHERWISE NOTED HARD SURFACE VAPOR BARRIER VERIFY IN FIELD HWY. HIGHWAY SHEET VINYL INCH WITH INCAND. INCANDESCENT WITHOUT INCLUDE WOOD INSULATION WATER HEATER LINOLEUM WATER PROOF LNDY.LAUNDRY W.W.F. WELDED WIRE FABRIC

SYMBOL REFERENCES

INTERIOR ELEVATION TAG

X KEY NOTE REFERENCE ( SEE

A3.0 DOOR SYMBOL REFERENCE

NUMBERED NOTES ON FLOOR PLAN)

- WINDOW SYMBOL REFERENCE ( SEE FLOOR PLAN AND

WINDOW SCHEDULE)

( SEE FLOOR PLAN AND WINDOW SCHEDULE)


LVT LUXURY VINYL TILE

SECTION DETAIL BUBBLE

#### SCOPE OF WORK

. CONVERT THE INTERIOR OF AN EXISTING COMMERCIAL SUITE INTO A NEW RECREATIONAL SPACE

REFER TO EXISTING SITE PLAN AND PROPOSED FLOOR PLANS FOR ROUTES OF TRAVEL.

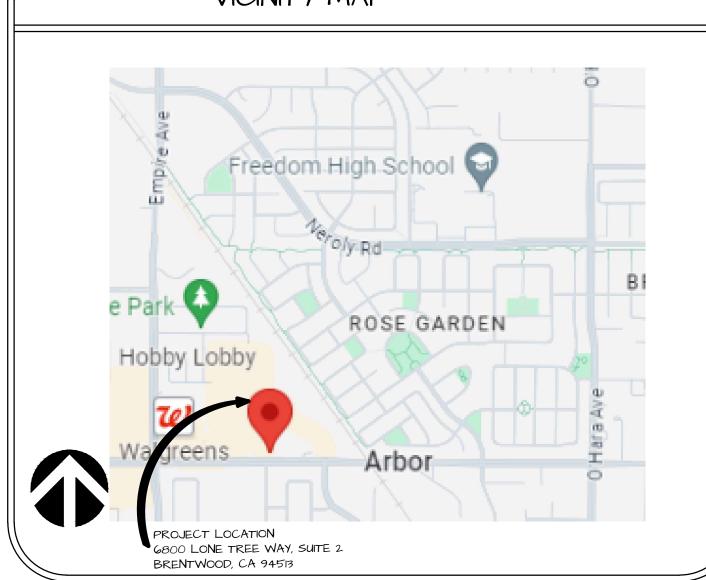

#### CODE INFORMATION

#### APPLICABLE CODES

2022 CALIFORNIA BUILDING STANDARDS ADMINISTRATIVE CODE PART I

2022 CALIFORNIA BUILDING CODE PART 2, VOLUME

2022 CALIFORNIA BUILDING CODE PART 2, VOLUME 2 2022 CALIFORNIA ELECTRICAL CODE PART 3

2022 CALIFORNIA MECHANICAL CODE PART 4 2022 CALIFORNIA PLUMBING CODE PART 5

2022 CALIFORNIA ENERGY CODE PART 6

2022 CALIFORNIA HISTORICAL BUILDING CODE PART 8

2022 CALIFORNIA FIRE CODE AS AMENDED BY THE CITY OF BRENTWOOD 2022 CALIFORNIA EXISTING BUILDING CODE PART 10

2022 CALIFORNIA BUILDING STANDARDS CODE (CALGREEN CODE) PART II 2022 CALIFORNIA REFERENCE STANDARDS CODE PART 12

ALL OTHER APPLICABLE LOCAL, STATE, AND FEDERAL LAWS AND REGULATIONS

THIS PROJECT IS A TENANT IMPROVEMENT WITH VENTILATION, SANITATION, HABITABILITY AND OCCUPANCY ISSUES ADDRESSED.

#### BLDG DATA :

PROJECT ADDRESS 6800 LONE TREE WAY, SUITE 2, BRENTWOOD, CA 94513

SUBAREA E OF THE PLANNED DEVELOPMENT THIRTY-EIGHT ZONE (PD-38)

OCCUPANCY CLASSIFICATIONS:

CONSTRUCTION TYPE TYPE V-B HR. RATED

FIRE SPRINKLERS:

TENANT IMPROVEMENT FLOOR AREA: 3,750 SQ. FT.

YEAR BUILT :

0.64 ACRES

#### SHEET INDEX

PROJECT CONTACTS

ST CLARE OF ASSISI ARCHITECTURE

EMAIL: CLAIRE.OBENSON@GMAIL.COM

420 BEATRICE CT, SUITE G-2

CONTACT: CLAIRE OBENSON

BRENTWOOD, CA 94513

PH: 415-948-7763

PROJECT CONTACTS

Ph: 925- 238-0444 CONTACT: MIKE PIERSON

MICHAEL AND P'ATANISHA PIERSON

EMAIL: mike@keycounselpc.com

420 BEATRICE CT., BRENTWOOD CA 94513

#### ARCHITECTURAL

PROPOSED FLOOR PLAN

COVER SHEET OVERALL SITE PLAN, ENLARGED SITE PLAN EXISTING FLOOR PLAN

CLARE

ARCHITECTURE

C - 31/861

Tel: (415) 948-7763

claire.obenson@gmail.com

Assisi

© St. Clare of Assisi Architecture 2024

Planning Submittal 07\_23\_24 Parking REV

07\_08\_24 05\_29\_24

C'est La Vie


6800 Lone Tree Way, Suite 2 Brentwood, CA 94513

Drawing Title

Cover Sheet

Job Number

Drawing Number

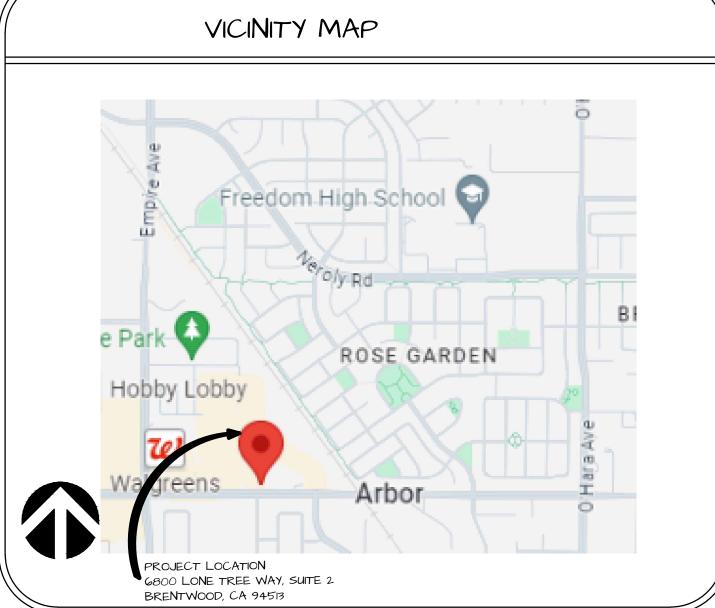

#### ACCESSIBLE PARKING CALCULATIONS

TOTAL NUMBER OF PARKING STALLS FOR BUILDING "E" =
REQUIRED NUMBER OF ACCESSIBLE PARKING STALLS FOR 1 TO 25 STALLS =


30 STALLS I VAN-ACCESSIBLE STALL REQUIRED

I VAN-ACCESSIBLE STALLS PROVIDED
I STANDARD ACCESSIBLE STALL
PROVIDED

(E) BUILDING

### ACCESSIBILITY NOTES

- I. WALKWAYS AND SIDEWALKS ALONG ACCESSIBLE ROUTES OF TRAVEL SHALL BE CONTINUOUS (48" MIN. WIDE CLEAR PATH) AND HAVE MAXIMUM  $\frac{1}{4}$ " CHANGE OF ELEVATION OR PROVIDE CHANGE IN LEVEL PER DETAIL 5 ON THIS SHEET. CHANGES IN ELEVATION GREATER THAN  $\frac{1}{2}$ " SHALL HAVE CURB RAMPS COMPLYING WITH CBC IIB-40G, PATH-OF-TRAVEL WALKWAYS SLOPES TO BE 5% MAX IN THE DIRECTION OF TRAVEL AND 2% MAX CROSS SLOPES. WALKWAYS EXCEEDING THESE PERCENTAGES SHALL HAVE RAMPS COMPLYING WITH CBC IIB-405.
- 2. ACCESSIBLE PARKING SPACES AND ACCESS AISLES SHALL NOT EXCEED 2% SLOPE IN ANY DIRECTION
- 3. CURB CUT RAMPS SHALL NOT EXCEED 8.3% SLOPE (1:12).
- 4. PROVIDE TRUNCATED DOMES AS DETECTABLE WARNING AT HAZARDOUS VEHICULAR AREAS 36" IN WIDTH PER 2022 CBC IIB-705.12.5
- 5. PROVIDE 60"X60" LEVEL LANDING AREA AT ALL ENTRY AND EXIT DOORS NOT TO EXCEED 1.5% SLOPE IN ANY DIRECTION
- 6. THRESHOLDS AT ALL DOORS SHALL NOT BE MORE THAN  $\frac{1}{2}$  ABOVE FLOOR AND LANDING ON BOTH SIDES OF THE THRESHOLD.

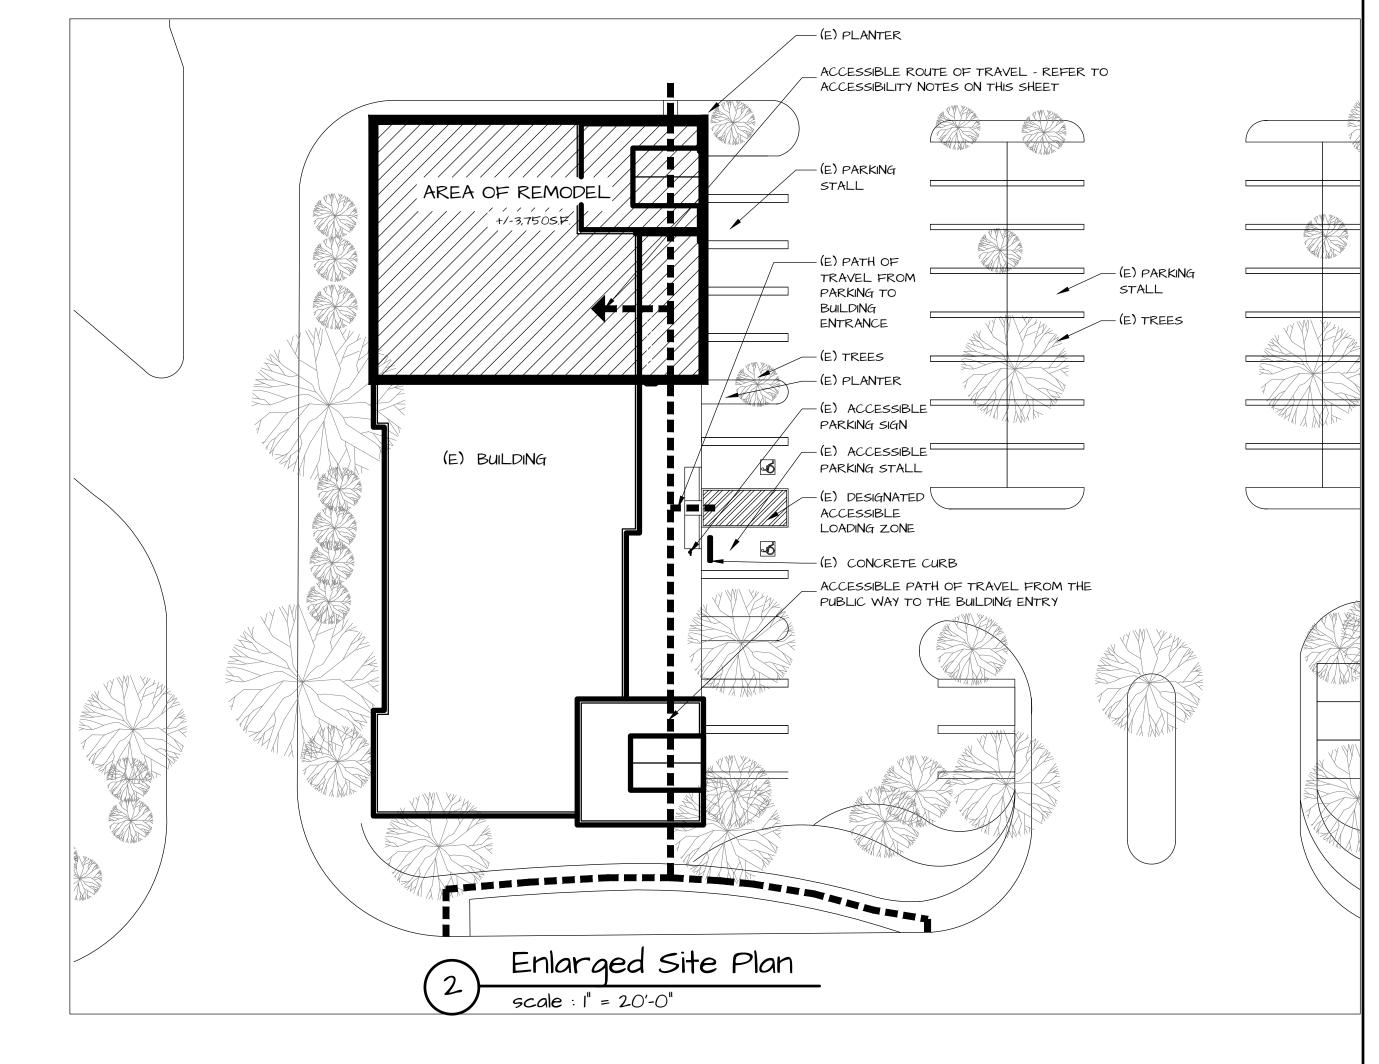


SITE PARKING CALCULATIONS
EXISTING PARKING SPACES PROVIDED: 507

EXISTING PARKING SPACES PROVIDED: 507							
Building	STATUS	ORIGINAL APPROVED SF.	ORIGINAL REQUIRED PARKING SPACES	ACTUAL SF.	PARKING SPACES USED		
A	EXISTING (NOT SHOWN)	46,000	184	TBD	PROJECTED	=	184
Aı	EXISTING (NOT SHOWN)	10,010	40	10,010	10,010 / 250	=	<b>4</b> 0
В	EXISTING (NOT SHOWN)	8,142	32	8,142	8,142/250	=	32
С	EXISTING	11,885	48	11705	11,705/250	=	32
D	FUTURE BUILDING	17,080	68	TBD	PROJECTED	=	68
E	THIS APPLICATION	7,491	30	7511	7511/250	=	30
+	EXISTING	9,490	38	9458	9458/250	=	38
H	EXISTING	4,970	20	5067	PROJECTED	=	20
G	EXISTING (NOT SHOWN)	2,200	9	6625	6625/250	=	27
			469				486

Site Parking Calculations

scale: NA

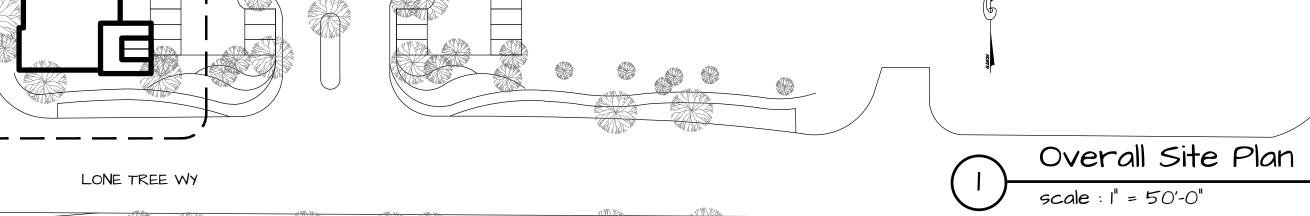

FUTURE BUILDING

(E) BUILDING

footage = +/-11,705sf

LONE TREE WY

AREA OF REMODEL, 3,750 SF

(E) PARKING

Drawing Title

Overall Site Plan, Enlarged Site Plan

Scale See drawing

Drawn By

Job Number 202413

Drawing Number

**λ** 1 Ω <sup>2</sup>

C-31861

ARCHITECTURE

 $S_{T.}$ 

CLARE

Assisi

Tel: (415) 948-7763 claire.obenson@gmail.com

St. Clare of Assisi Architecture 2024

 Planning Submittal
 08\_07\_24

 Parking REV
 07\_23\_24


 Submittal
 07\_08\_24

 Meeting
 06\_06\_24

 Meeting
 05\_29\_24

C'est La Vie

6800 Lone Tree Way, Suite 2 Brentwood, CA 94513

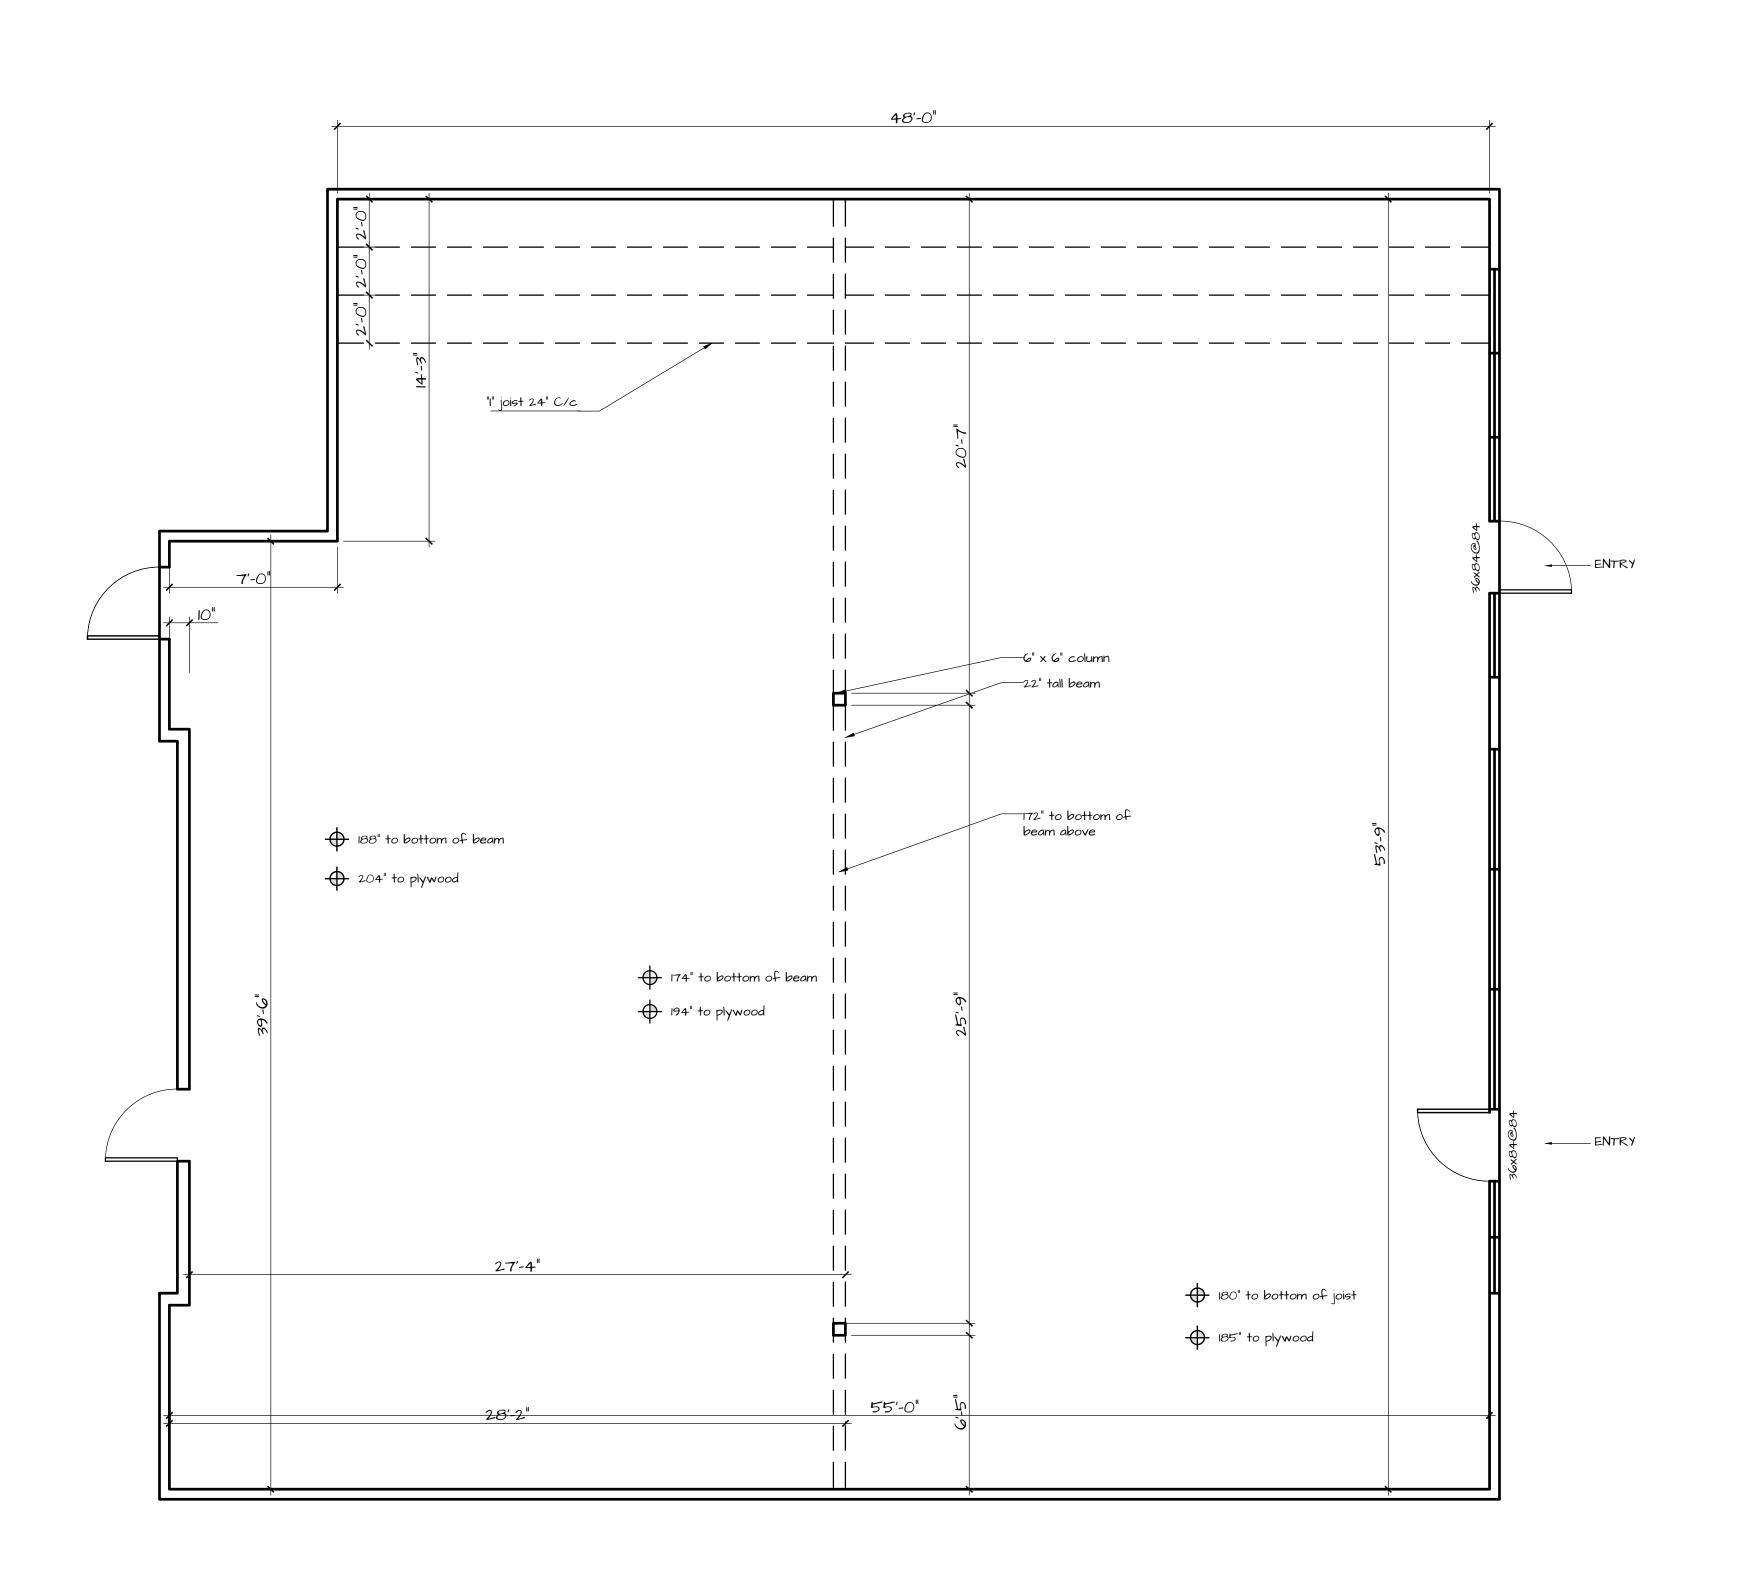

 $S_{\text{T.}}$ CLARE

ΟF

 $A_{ssisi}$ 

ARCHITECTURE



claire.obenson@gmail.com

© St. Clare of Assisi Architecture 2024

08\_07\_24 Planning Submittal 07\_23\_24 Parking REV 07\_08\_24 06\_06\_24

C'est La Vie

05\_29\_24


6800 Lone Tree Way, Suite 2 Brentwood, CA 94513

Drawing Title

**Existing Floor Plan** 

1/4"=1'-0"

Job Number 202413 Drawing Number

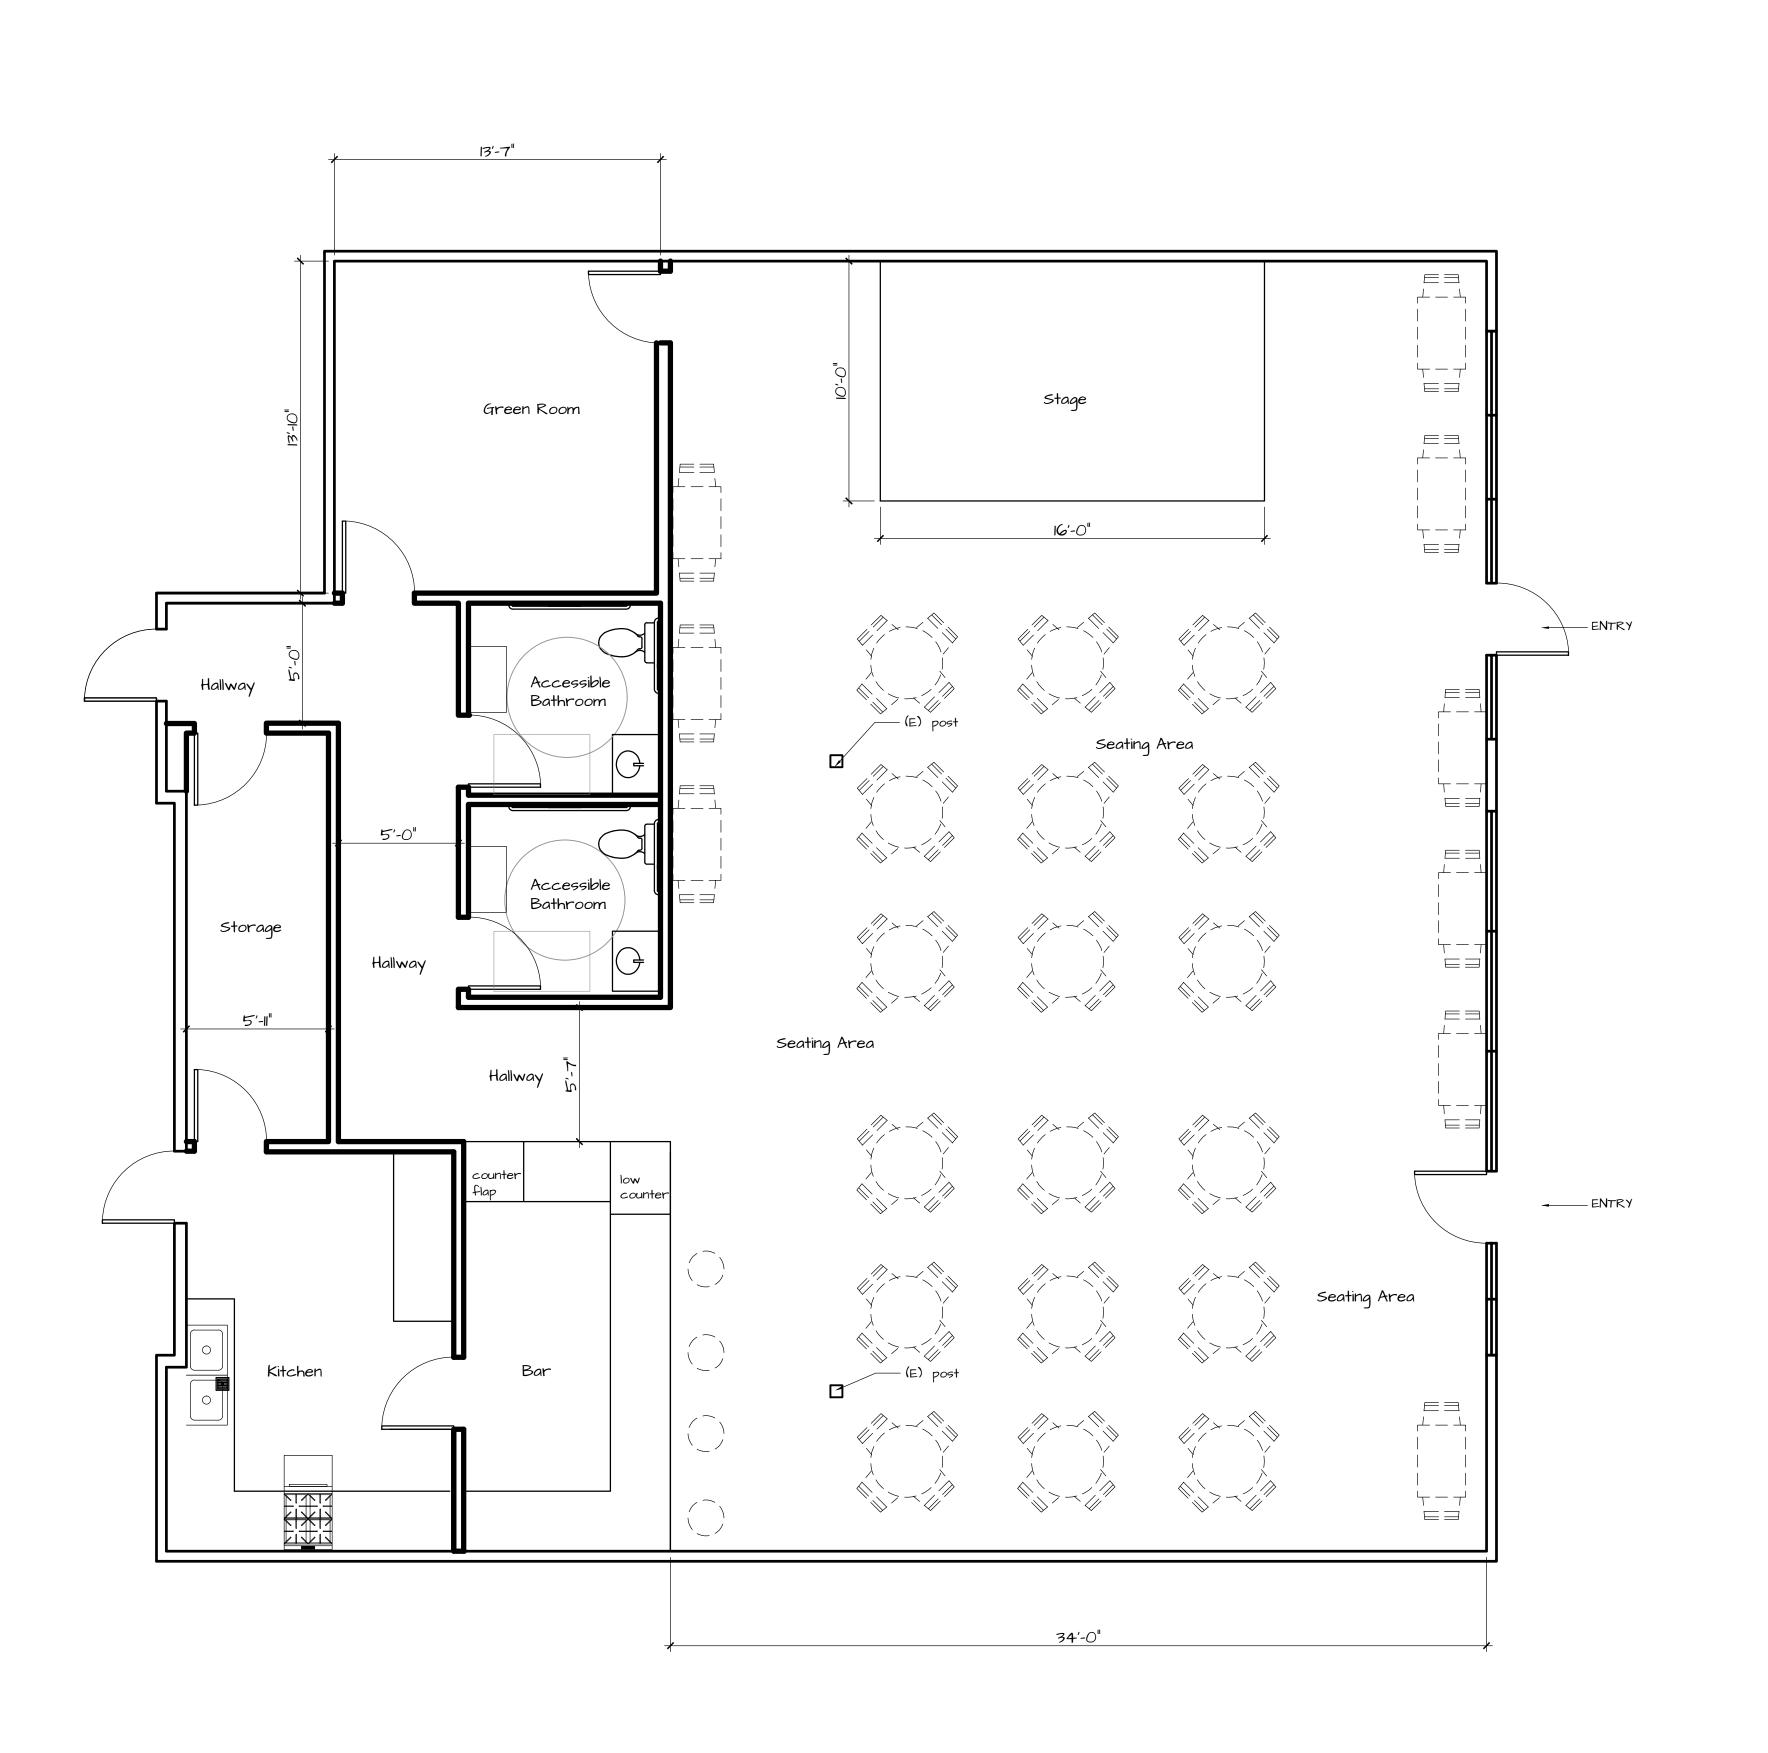

S<sub>T.</sub> CLARE

O F

 $A_{ssisi}$ 

ARCHITECTURE



claire.obenson@gmail.com

© St. Clare of Assisi Architecture 2024

 Planning Submittal
 08\_07\_24

 Parking REV
 07\_23\_24

 Submittal
 07\_08\_24

C'est La Vie

05\_29\_24

6800 Lone Tree Way, Suite 2 Brentwood, CA 94513

Drawing Title

Proposed Floor Plan

Scale 1/4"=1'-0"

Job Number 202413

Drawing Number

A202